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Drawing Name: 115232—DP01.dwg, Plotted: Jul 02, 2019

TBM1 — ELEVATION 186.773

NAIL IN HYDRO POLE LOCATED ON WEST SIDE OF GREY ROAD #2, 3RD HYDRO POLE SOUTH OF POLICE AND EMS STATION.

TBM2 — ELEVATION 186.555

NAIL IN HYDRO POLE LOCATED ON NORTH SIDE OF CLARK ST., APPROXIMATELY 160m WEST OF INTERSECTION OF CLARK ST. & GREY ROAD #2.

TBM3 — ELEVATION 198.028


NAIL IN HYDRO POLE LOCATED ON WEST SIDE OF CLARK ST., APPROXIMATELY 500m WEST OF INTERSECTION OF CLARK ST. AND GREY ROAD #2.

D. J. HURLEY

PRE-DEVELOPMENT DRAINAGE PLAN

F	DESIGN: ARO	FILE: 115232	[
	DRAWN: DEP/RD	DATE: JAN 2017	
	CHECK: DJH	SCALE: 1 : 1,500	

DP-1

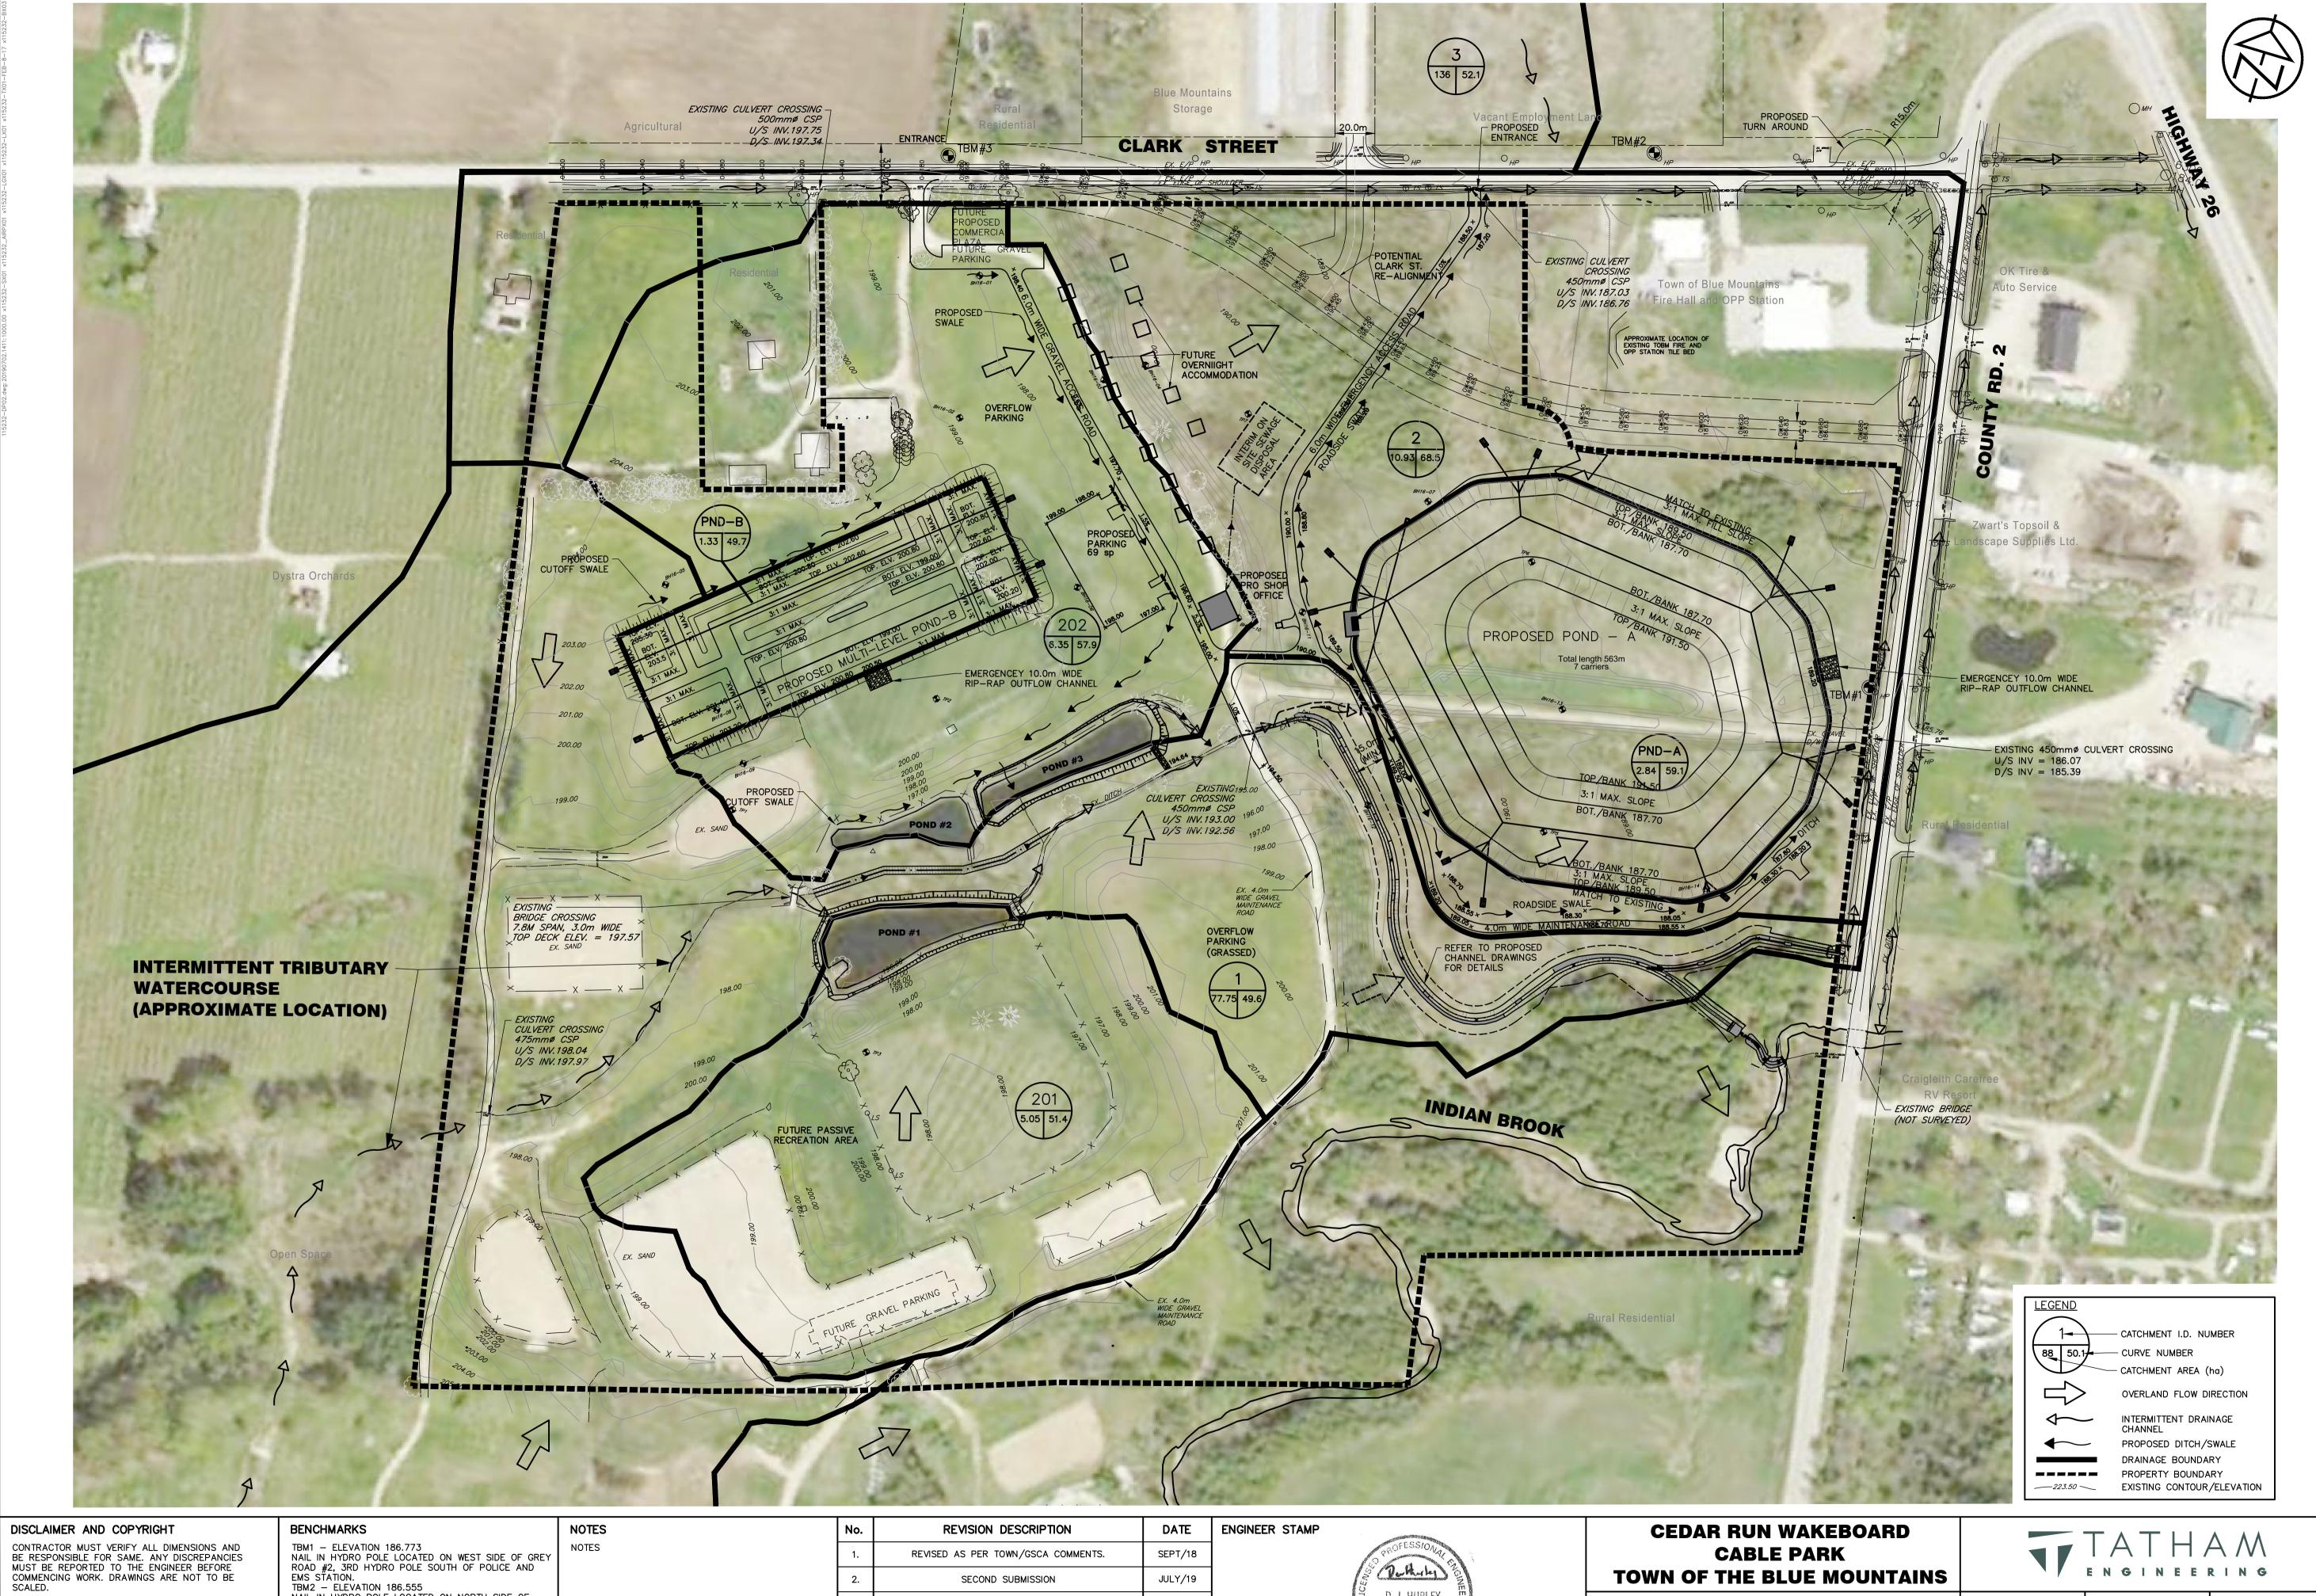

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Drawing Name: 115232—DP02.dwg, Plotted: Jul 02, 2019

TBM2 — ELEVATION 186.555

NAIL IN HYDRO POLE LOCATED ON NORTH SIDE OF CLARK ST., APPROXIMATELY 160m WEST OF INTERSECTION OF CLARK ST. & GREY ROAD #2. TBM3 - ELEVATION 198.028

NAIL IN HYDRO POLE LOCATED ON WEST SIDE OF CLARK ST., APPROXIMATELY 500m WEST OF INTERSECTION OF CLARK ST. AND GREY ROAD #2.





TOWN OF THE BLUE MOUNTAINS


POST DEVELOPMENT DRAINAGE PLAN


FILE: 115232 DATE: **JAN 2017** CHECK: DJH SCALE: 1: 1,500


DP-2

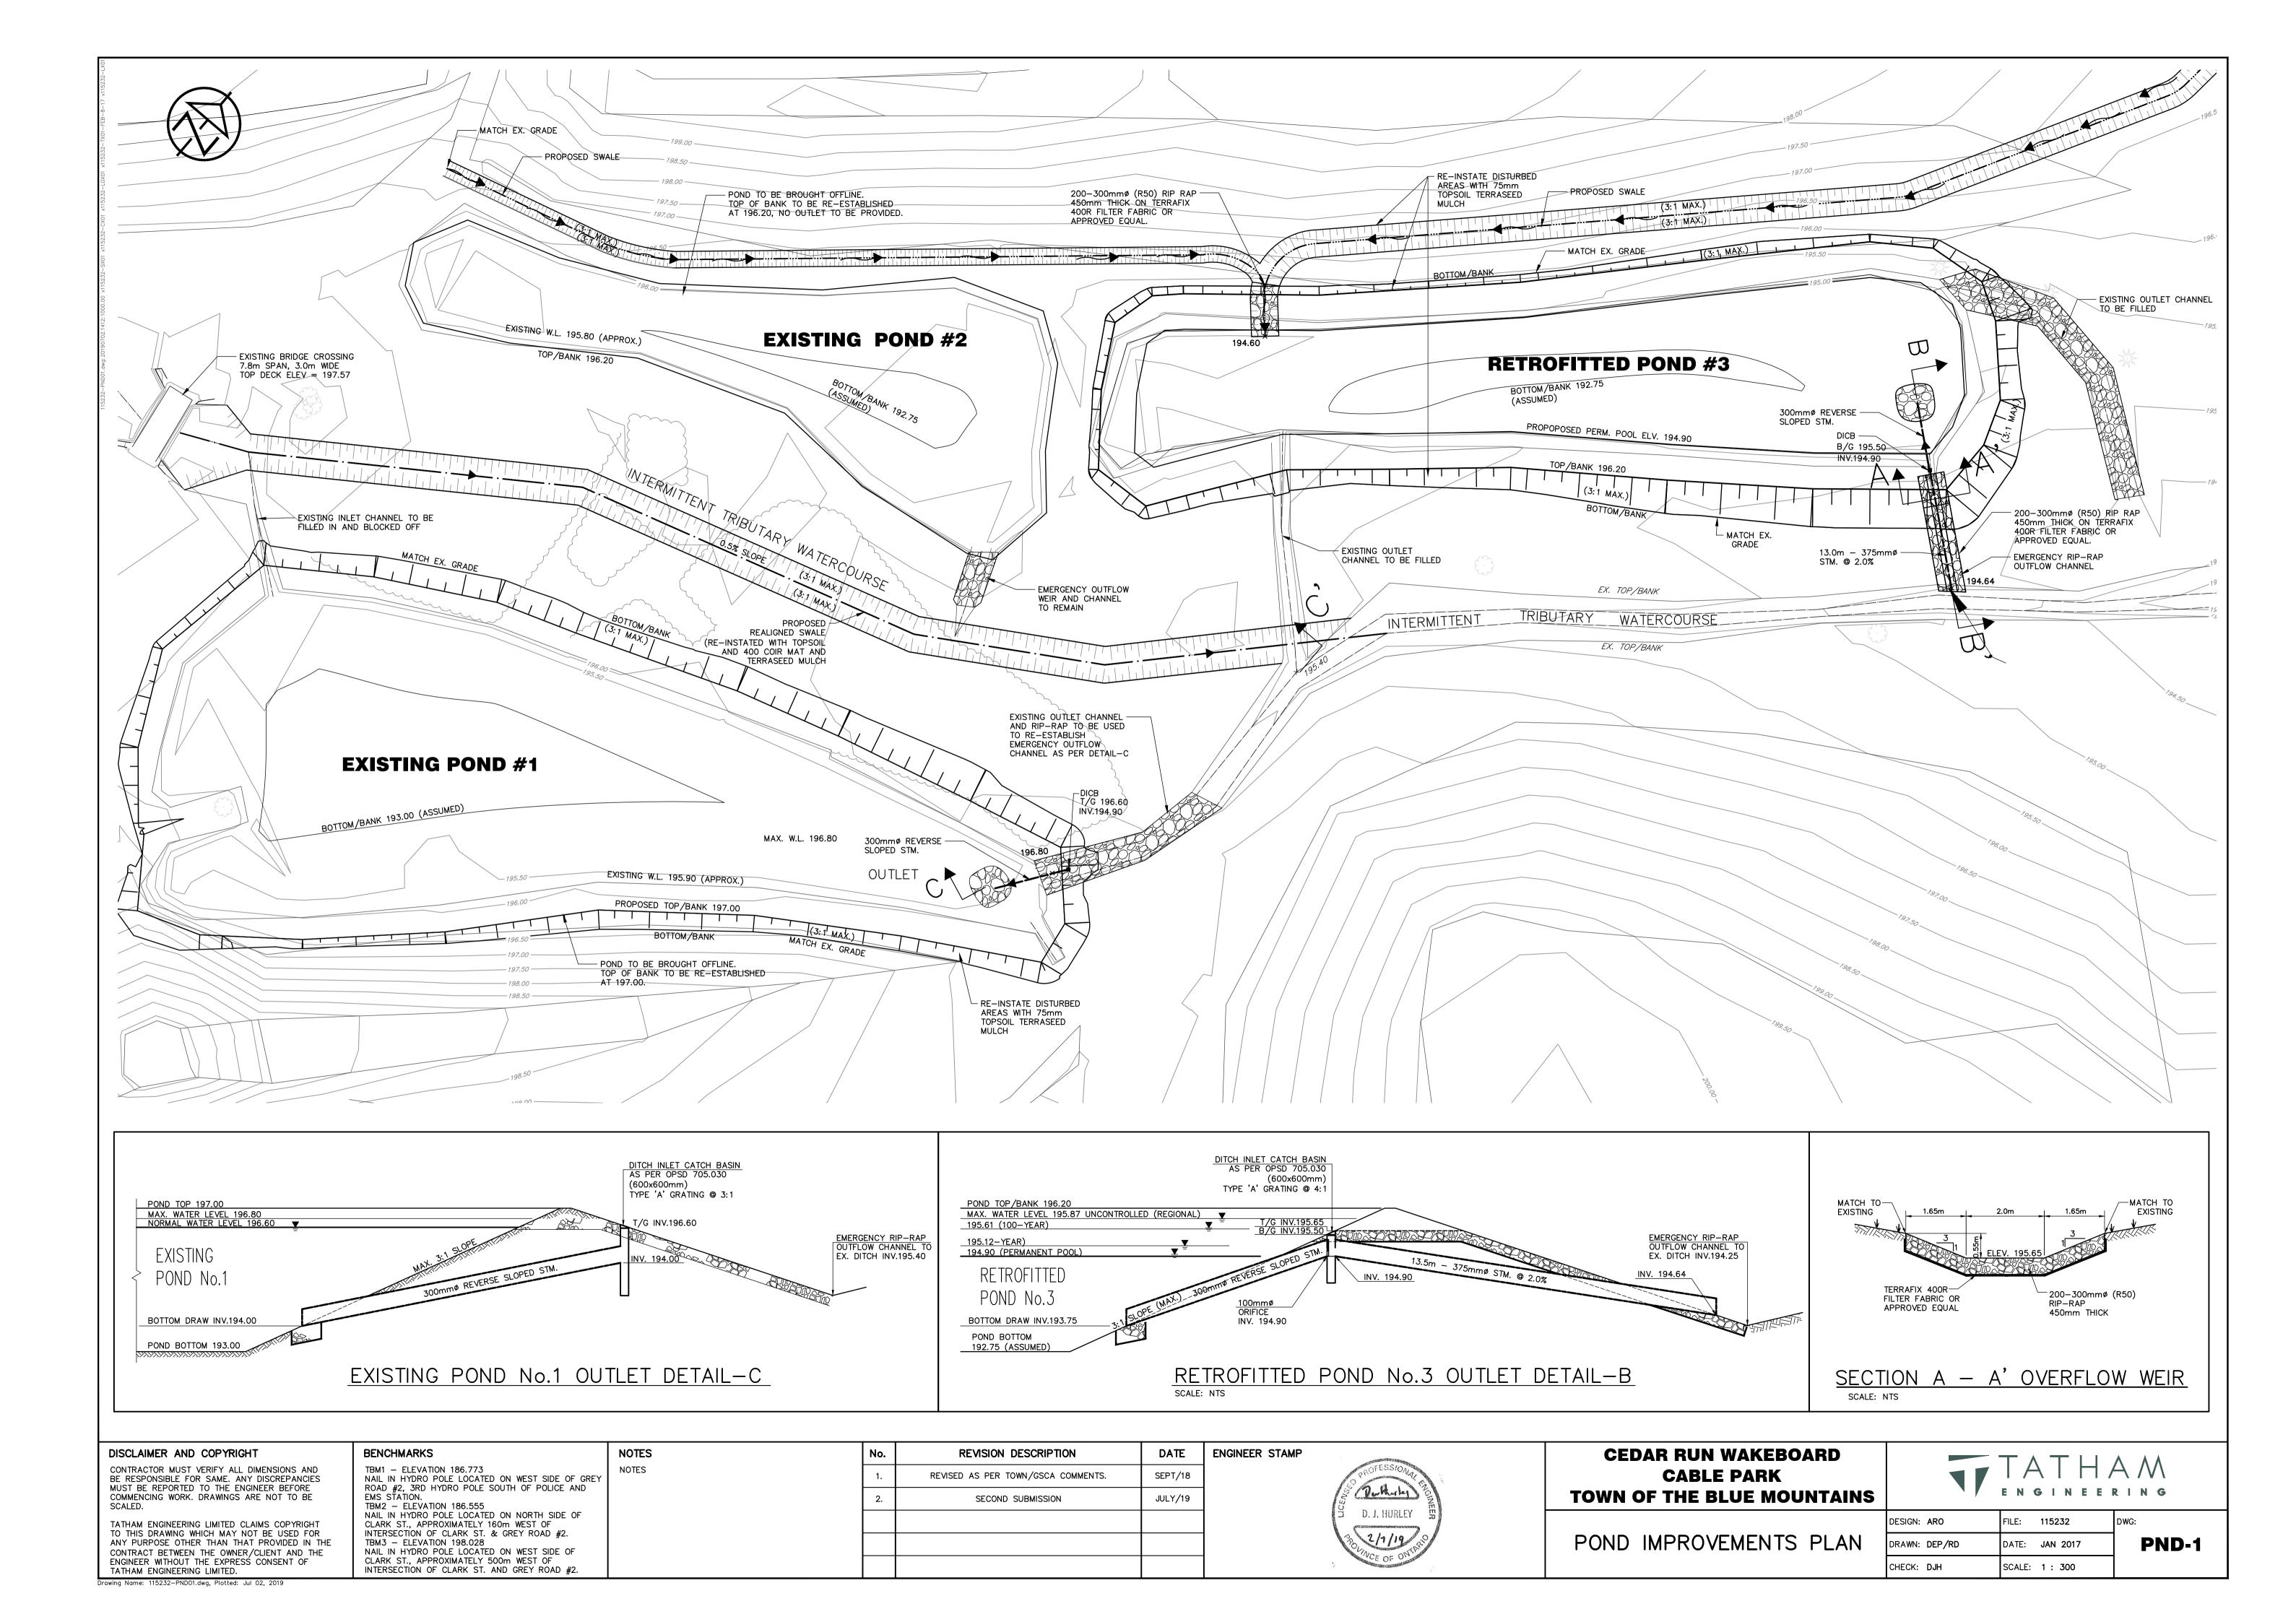


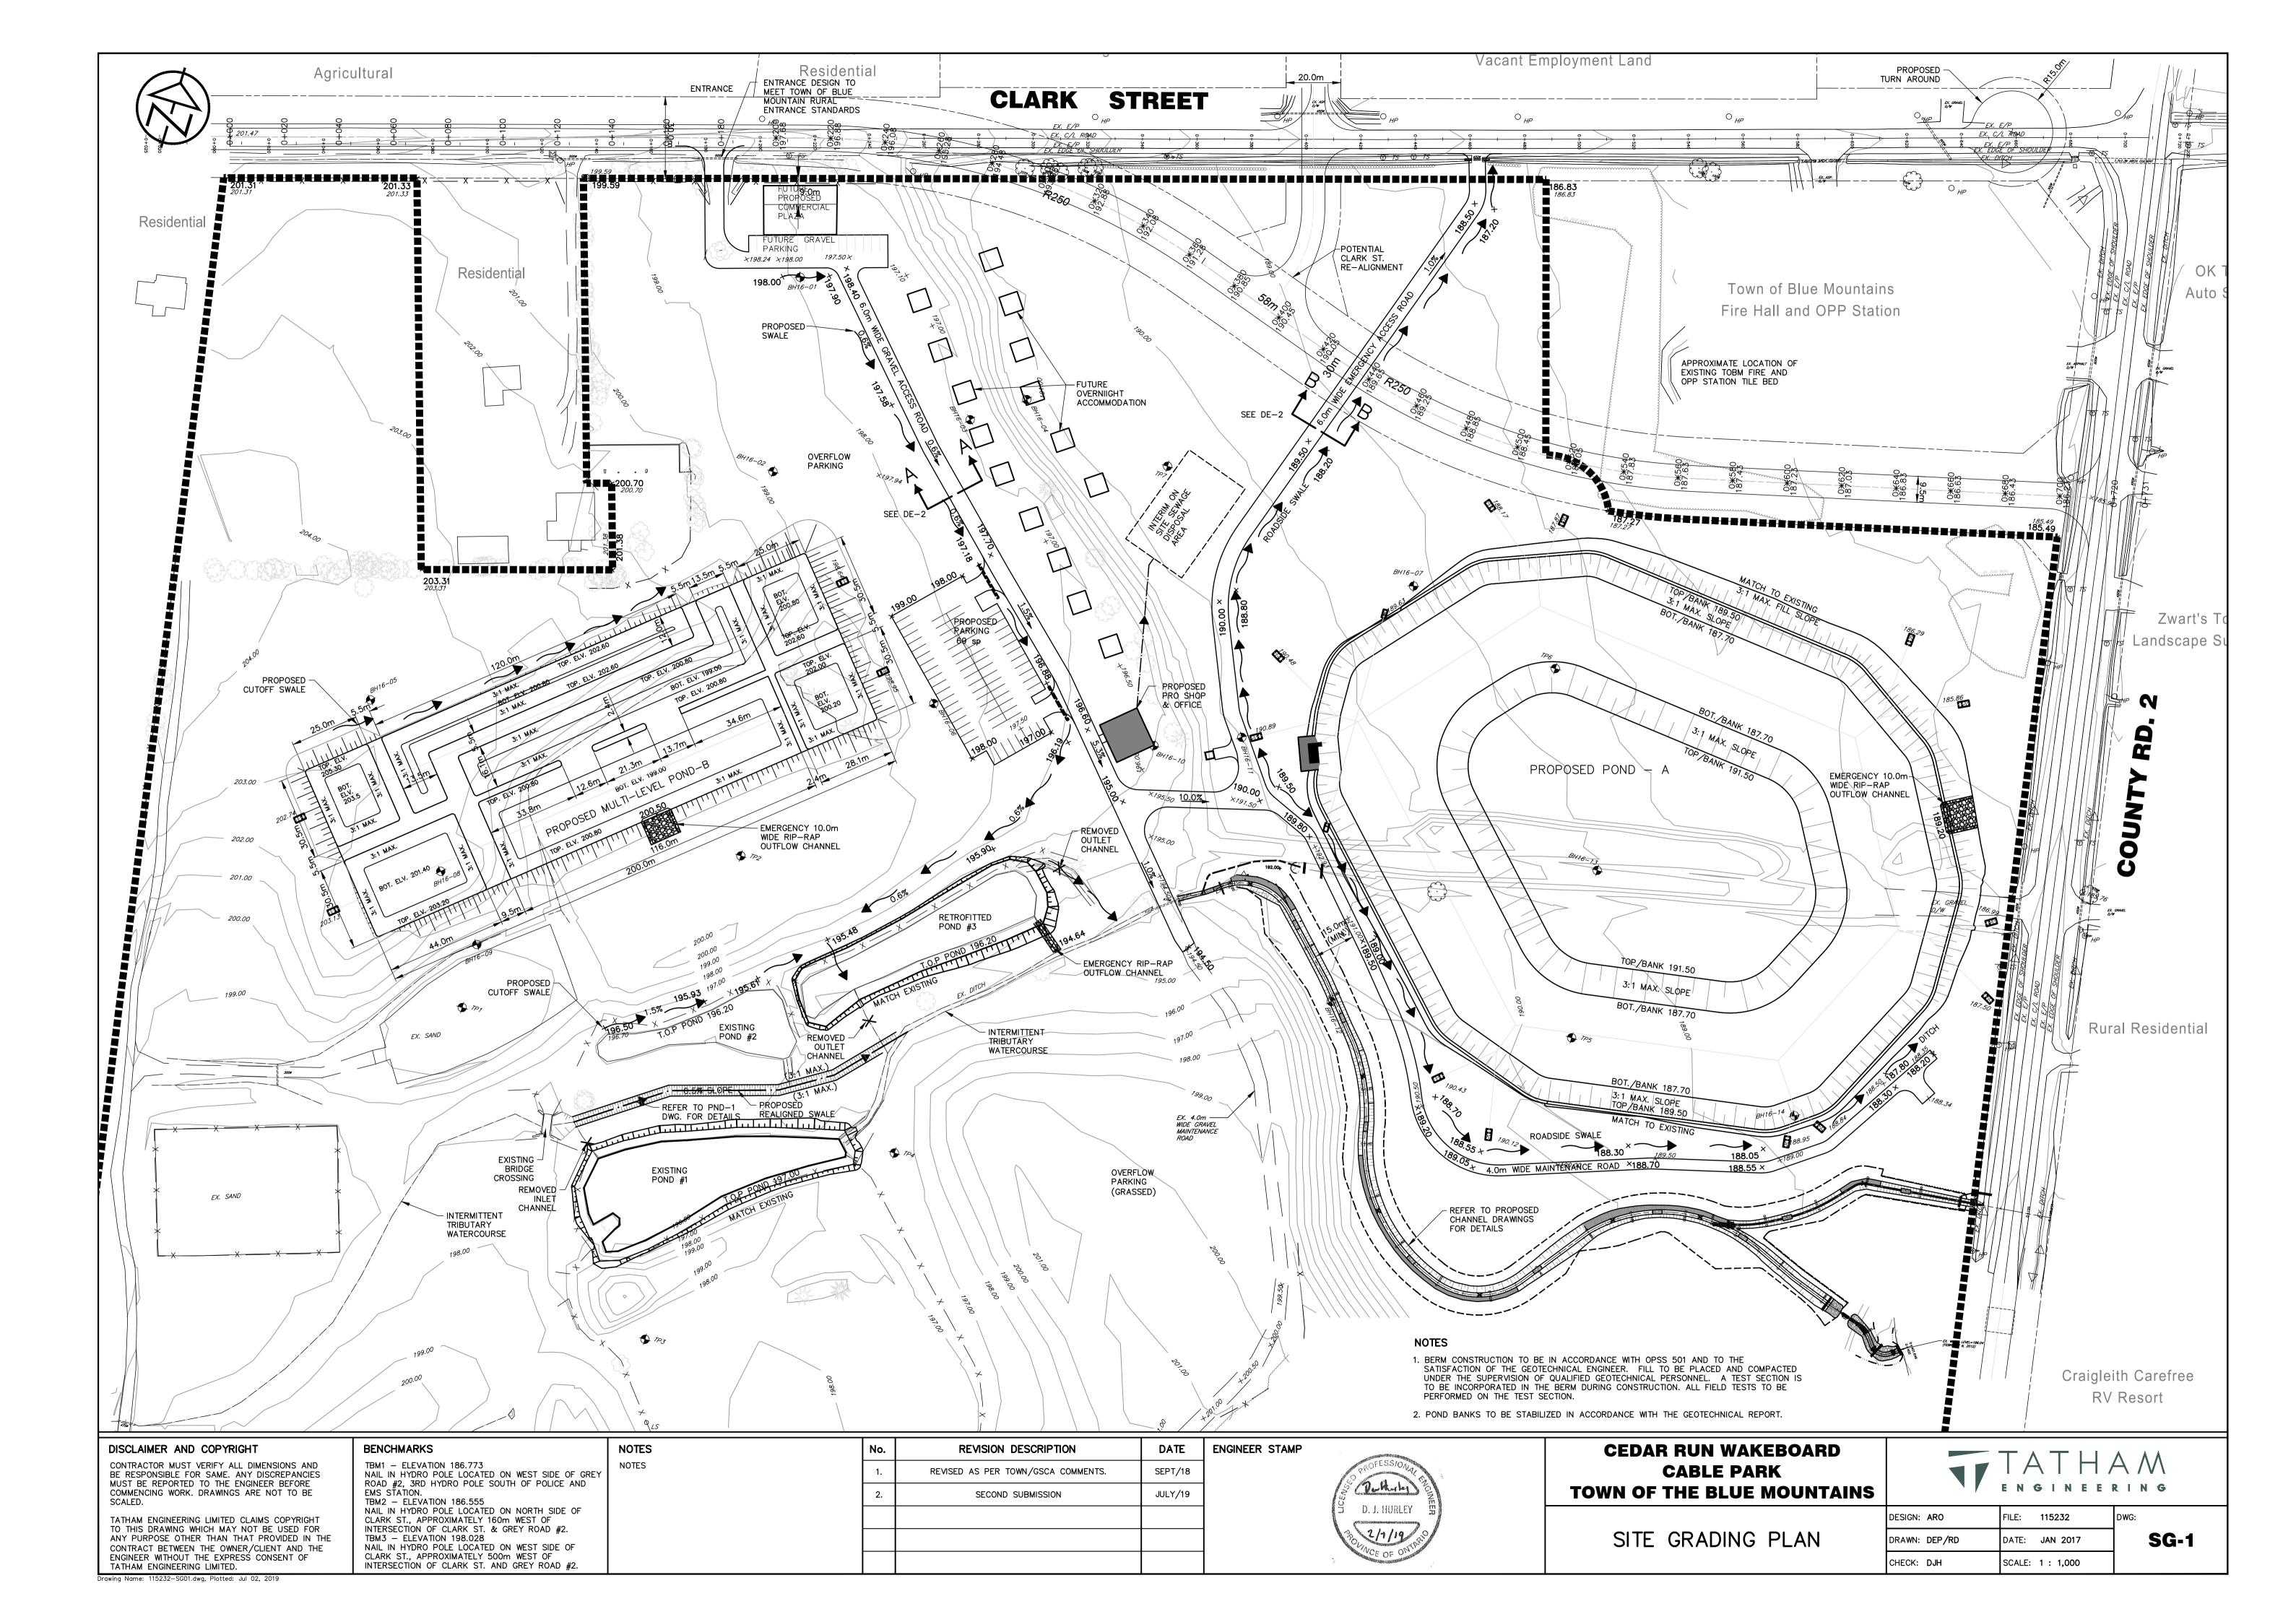


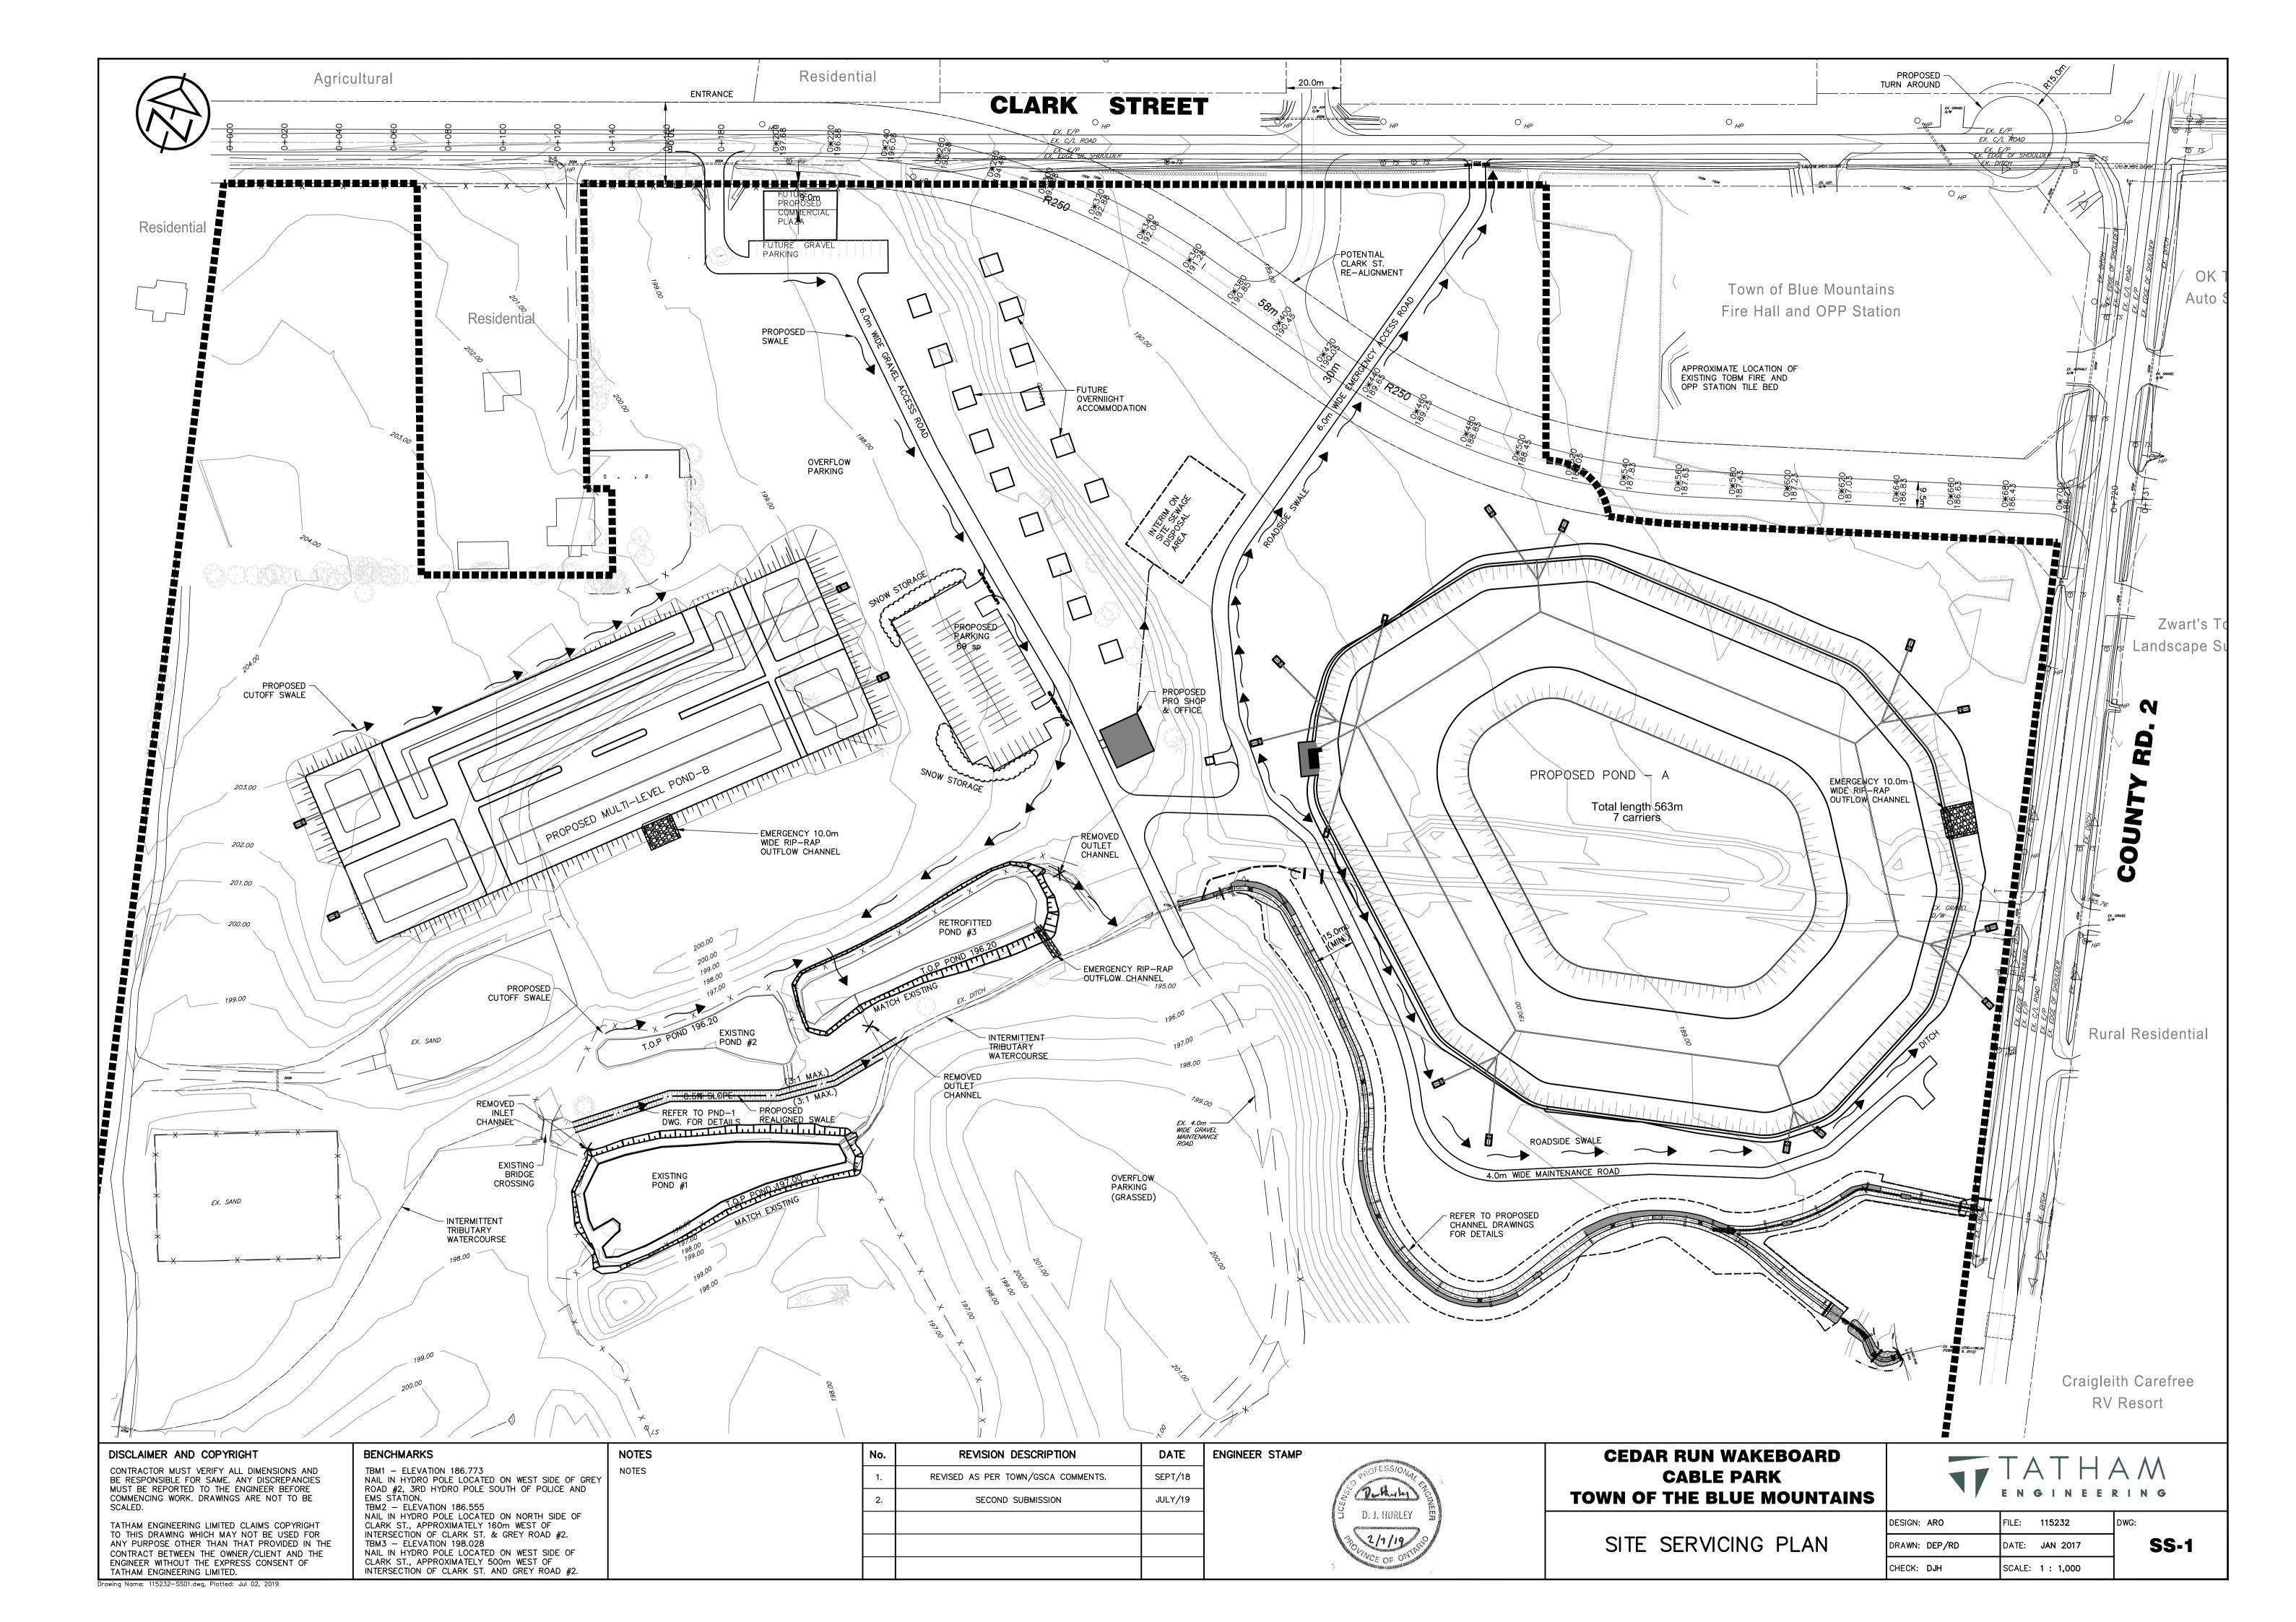


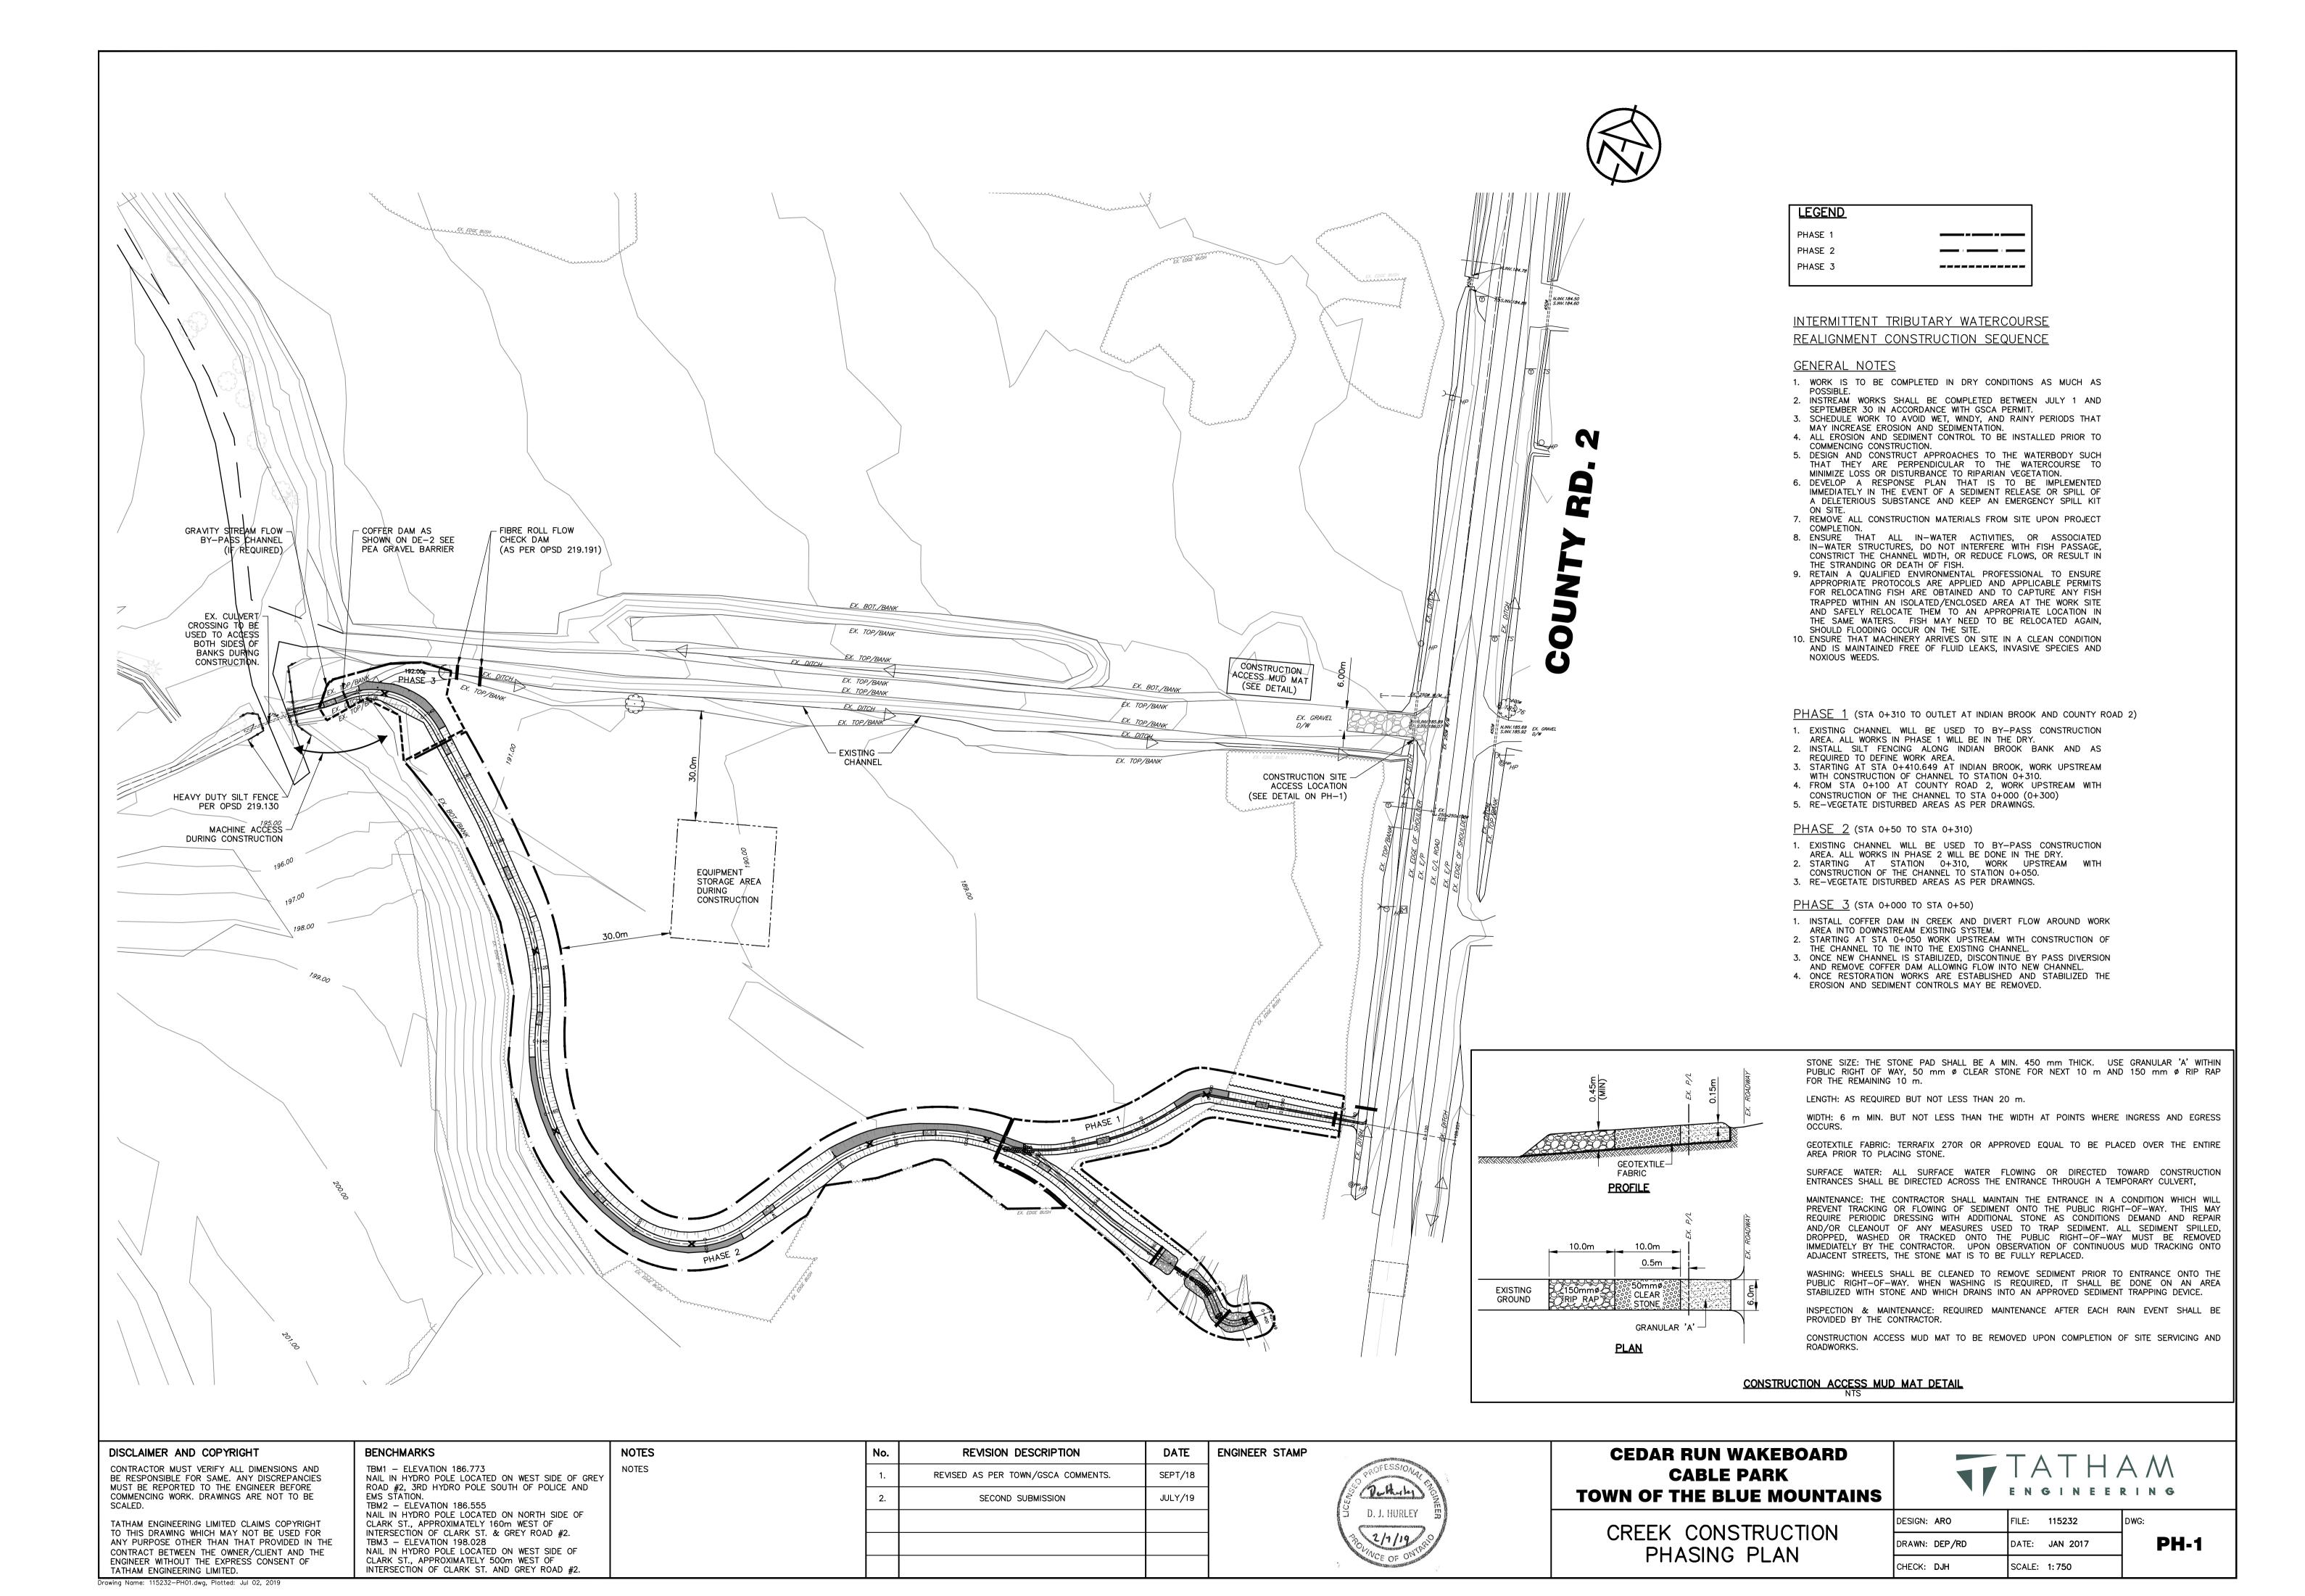


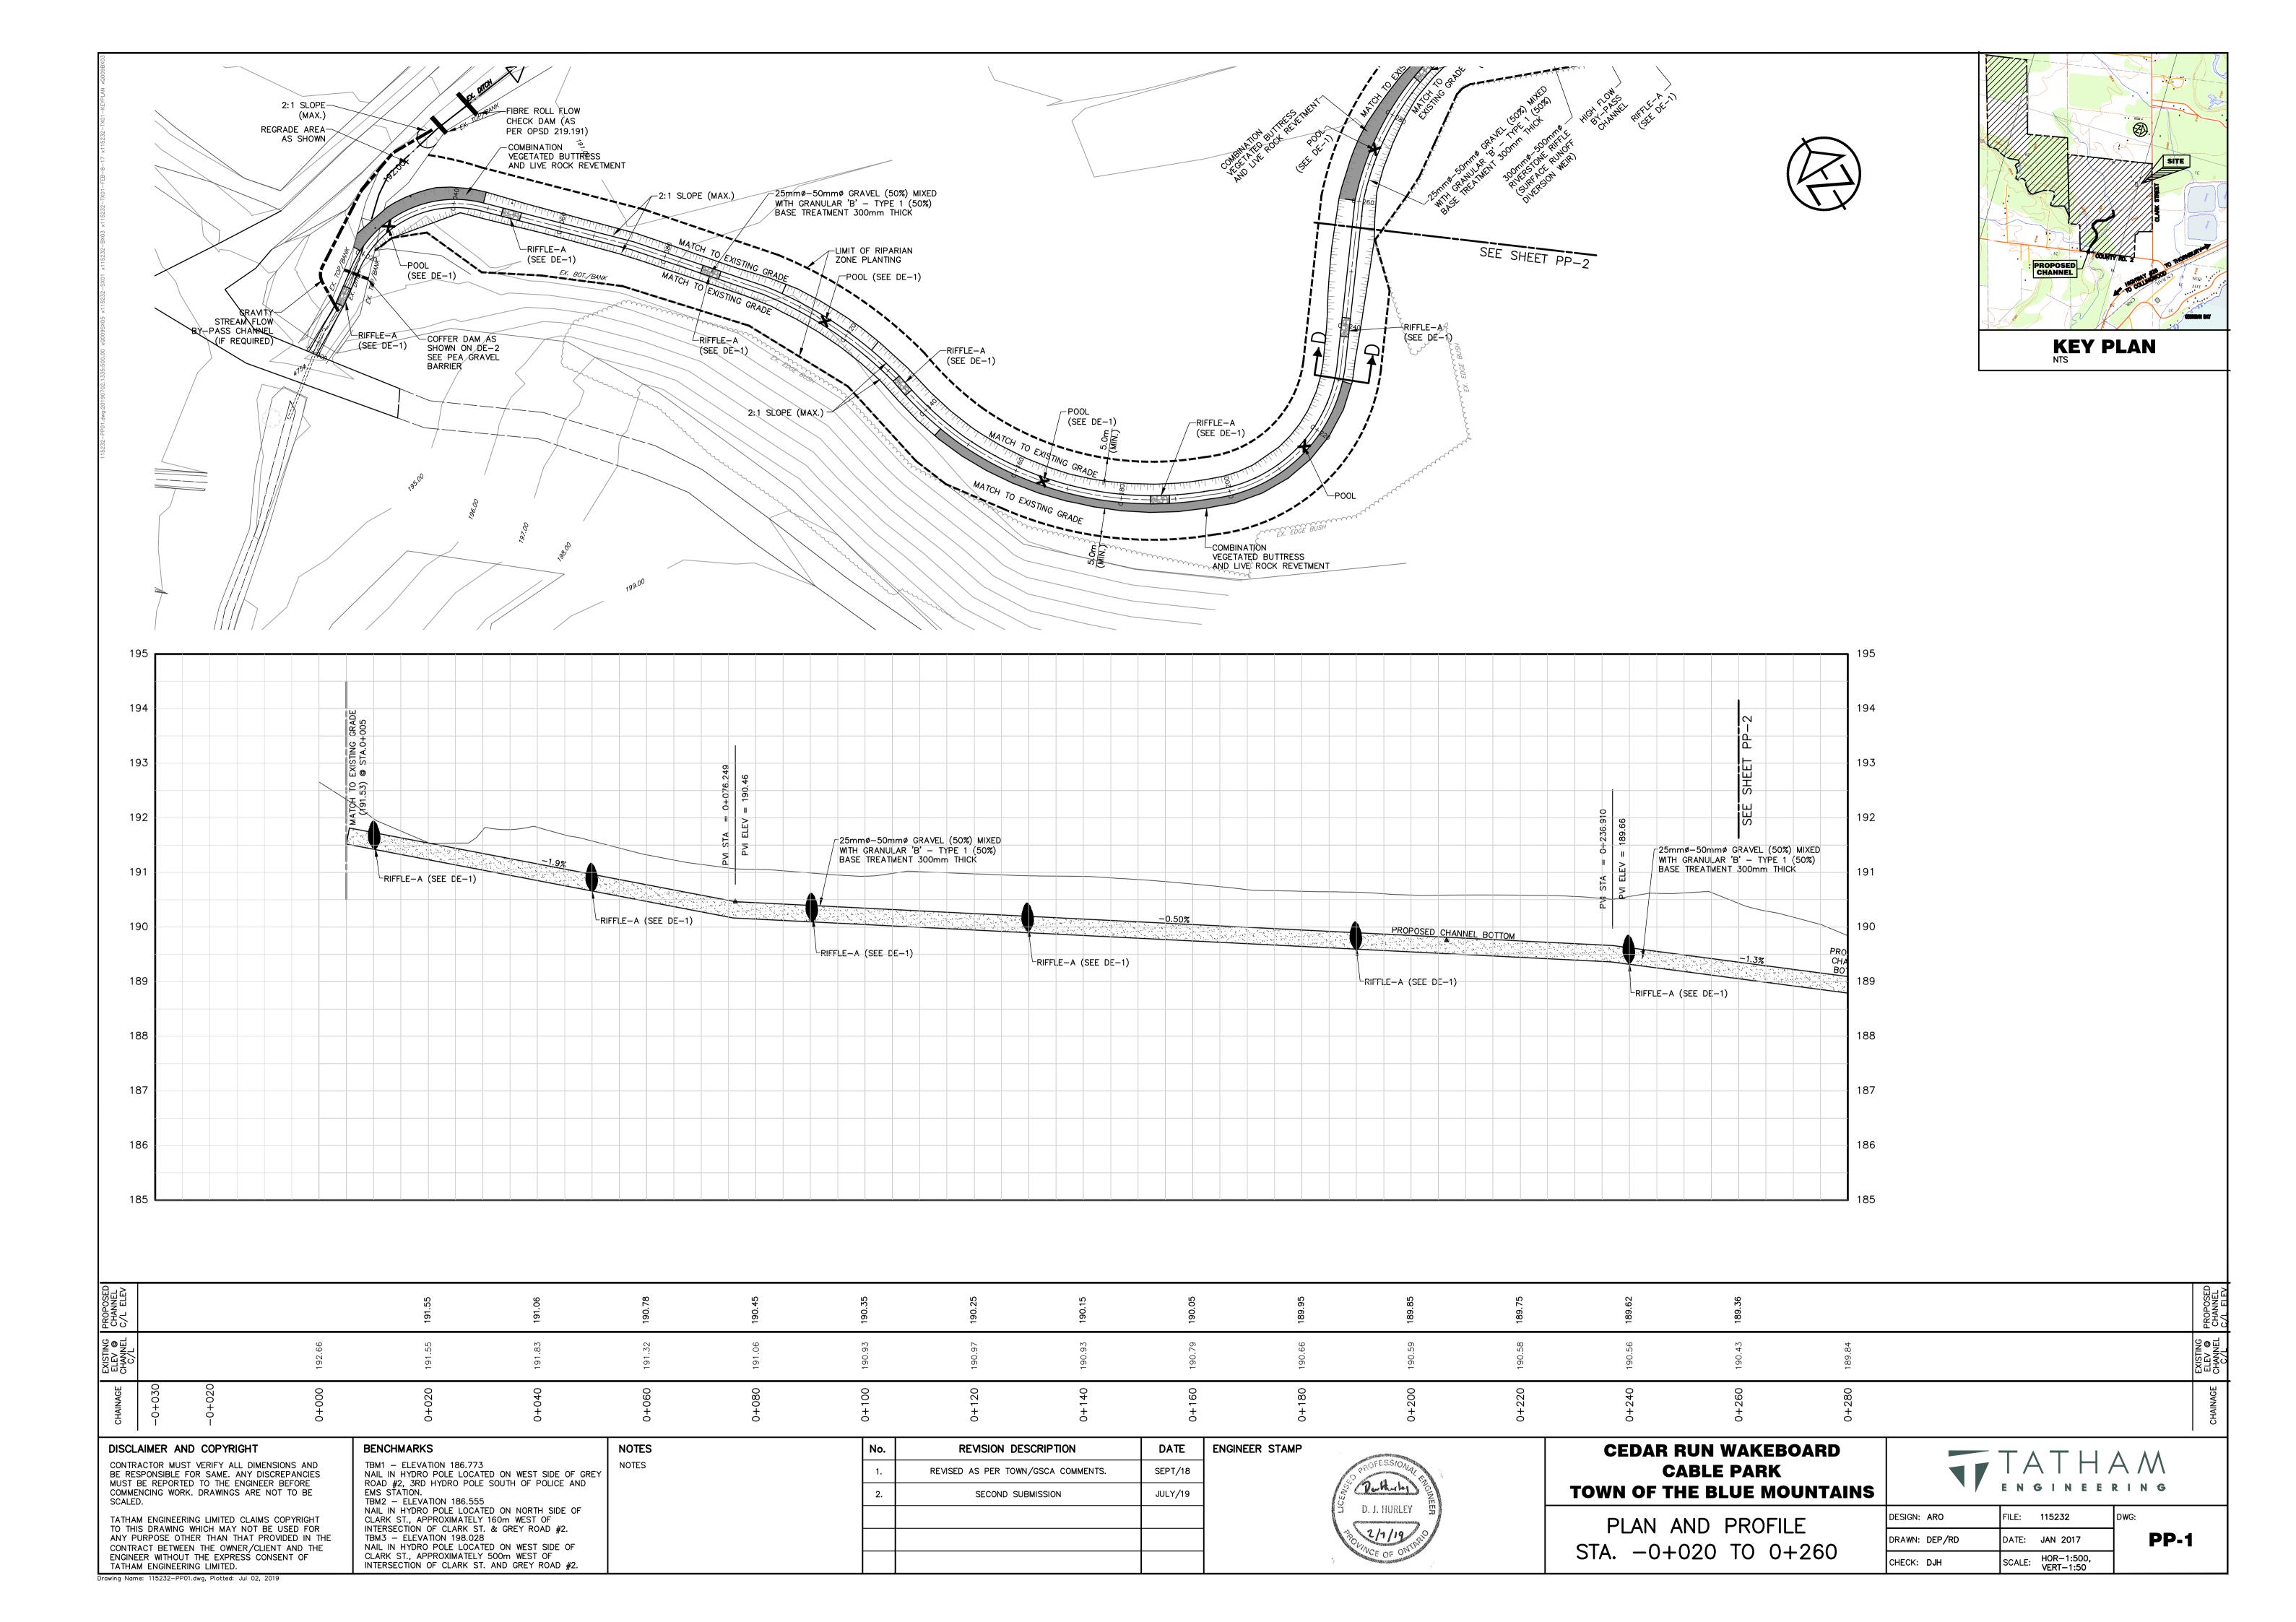

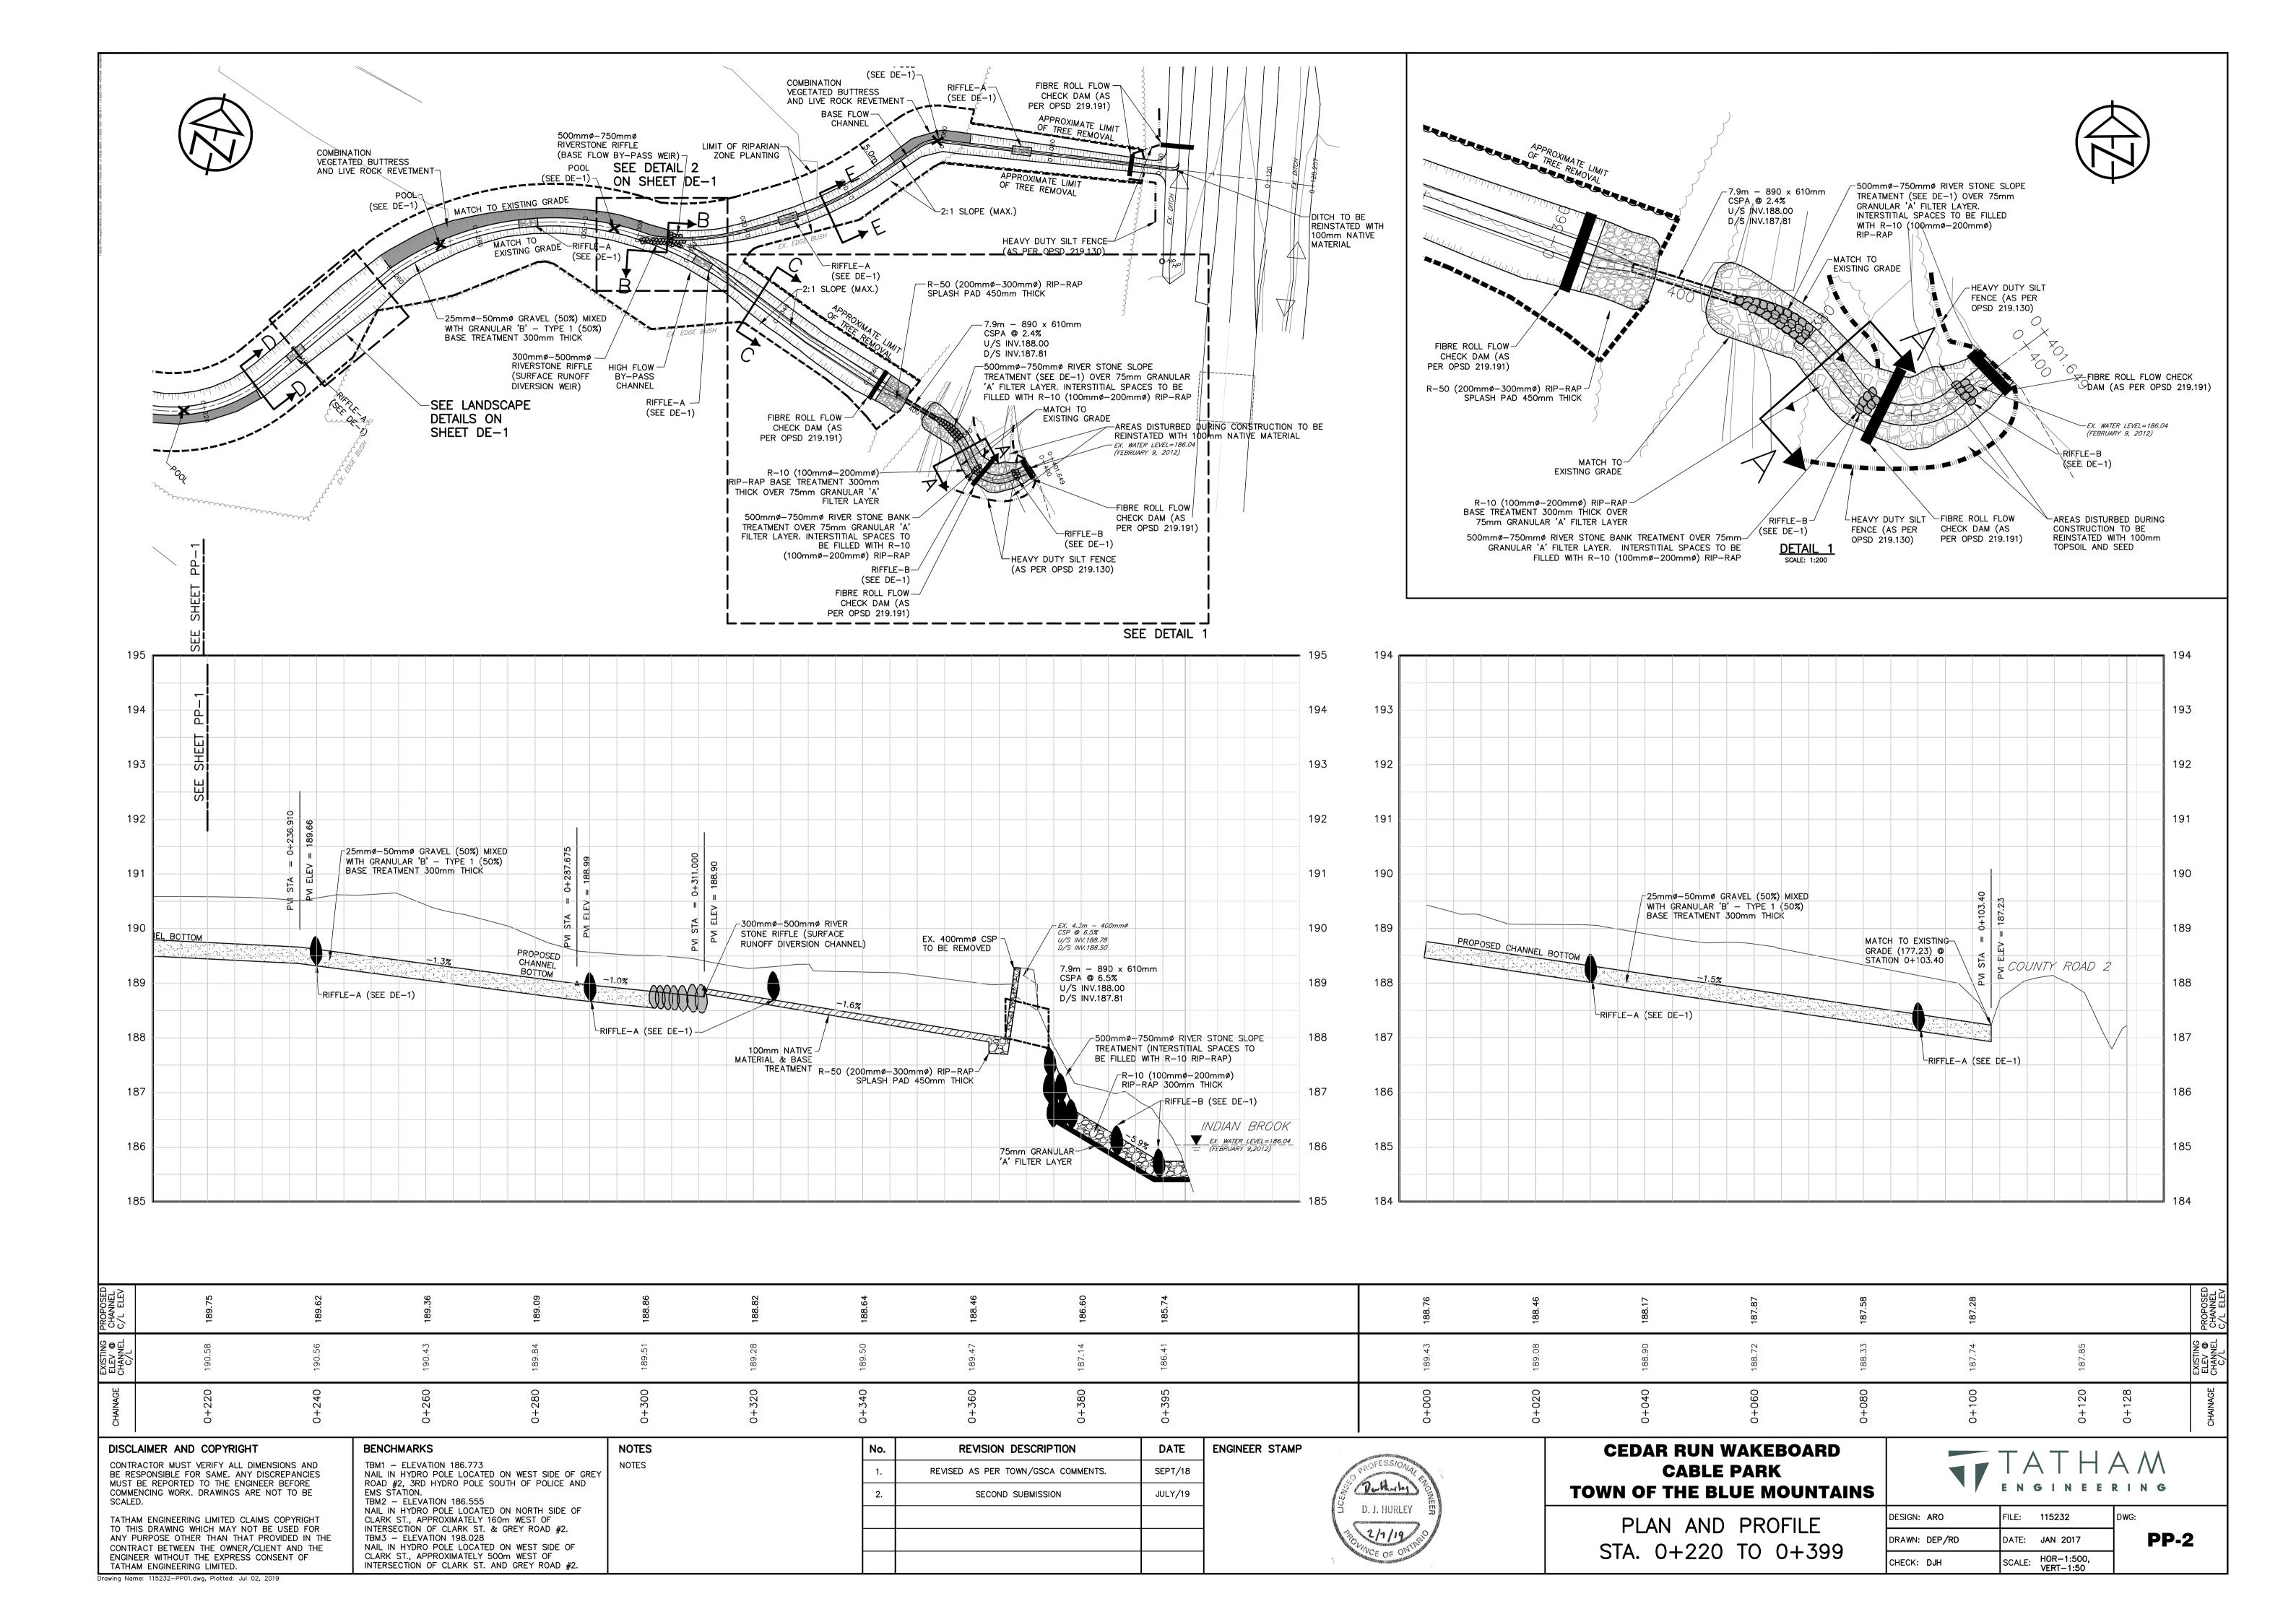

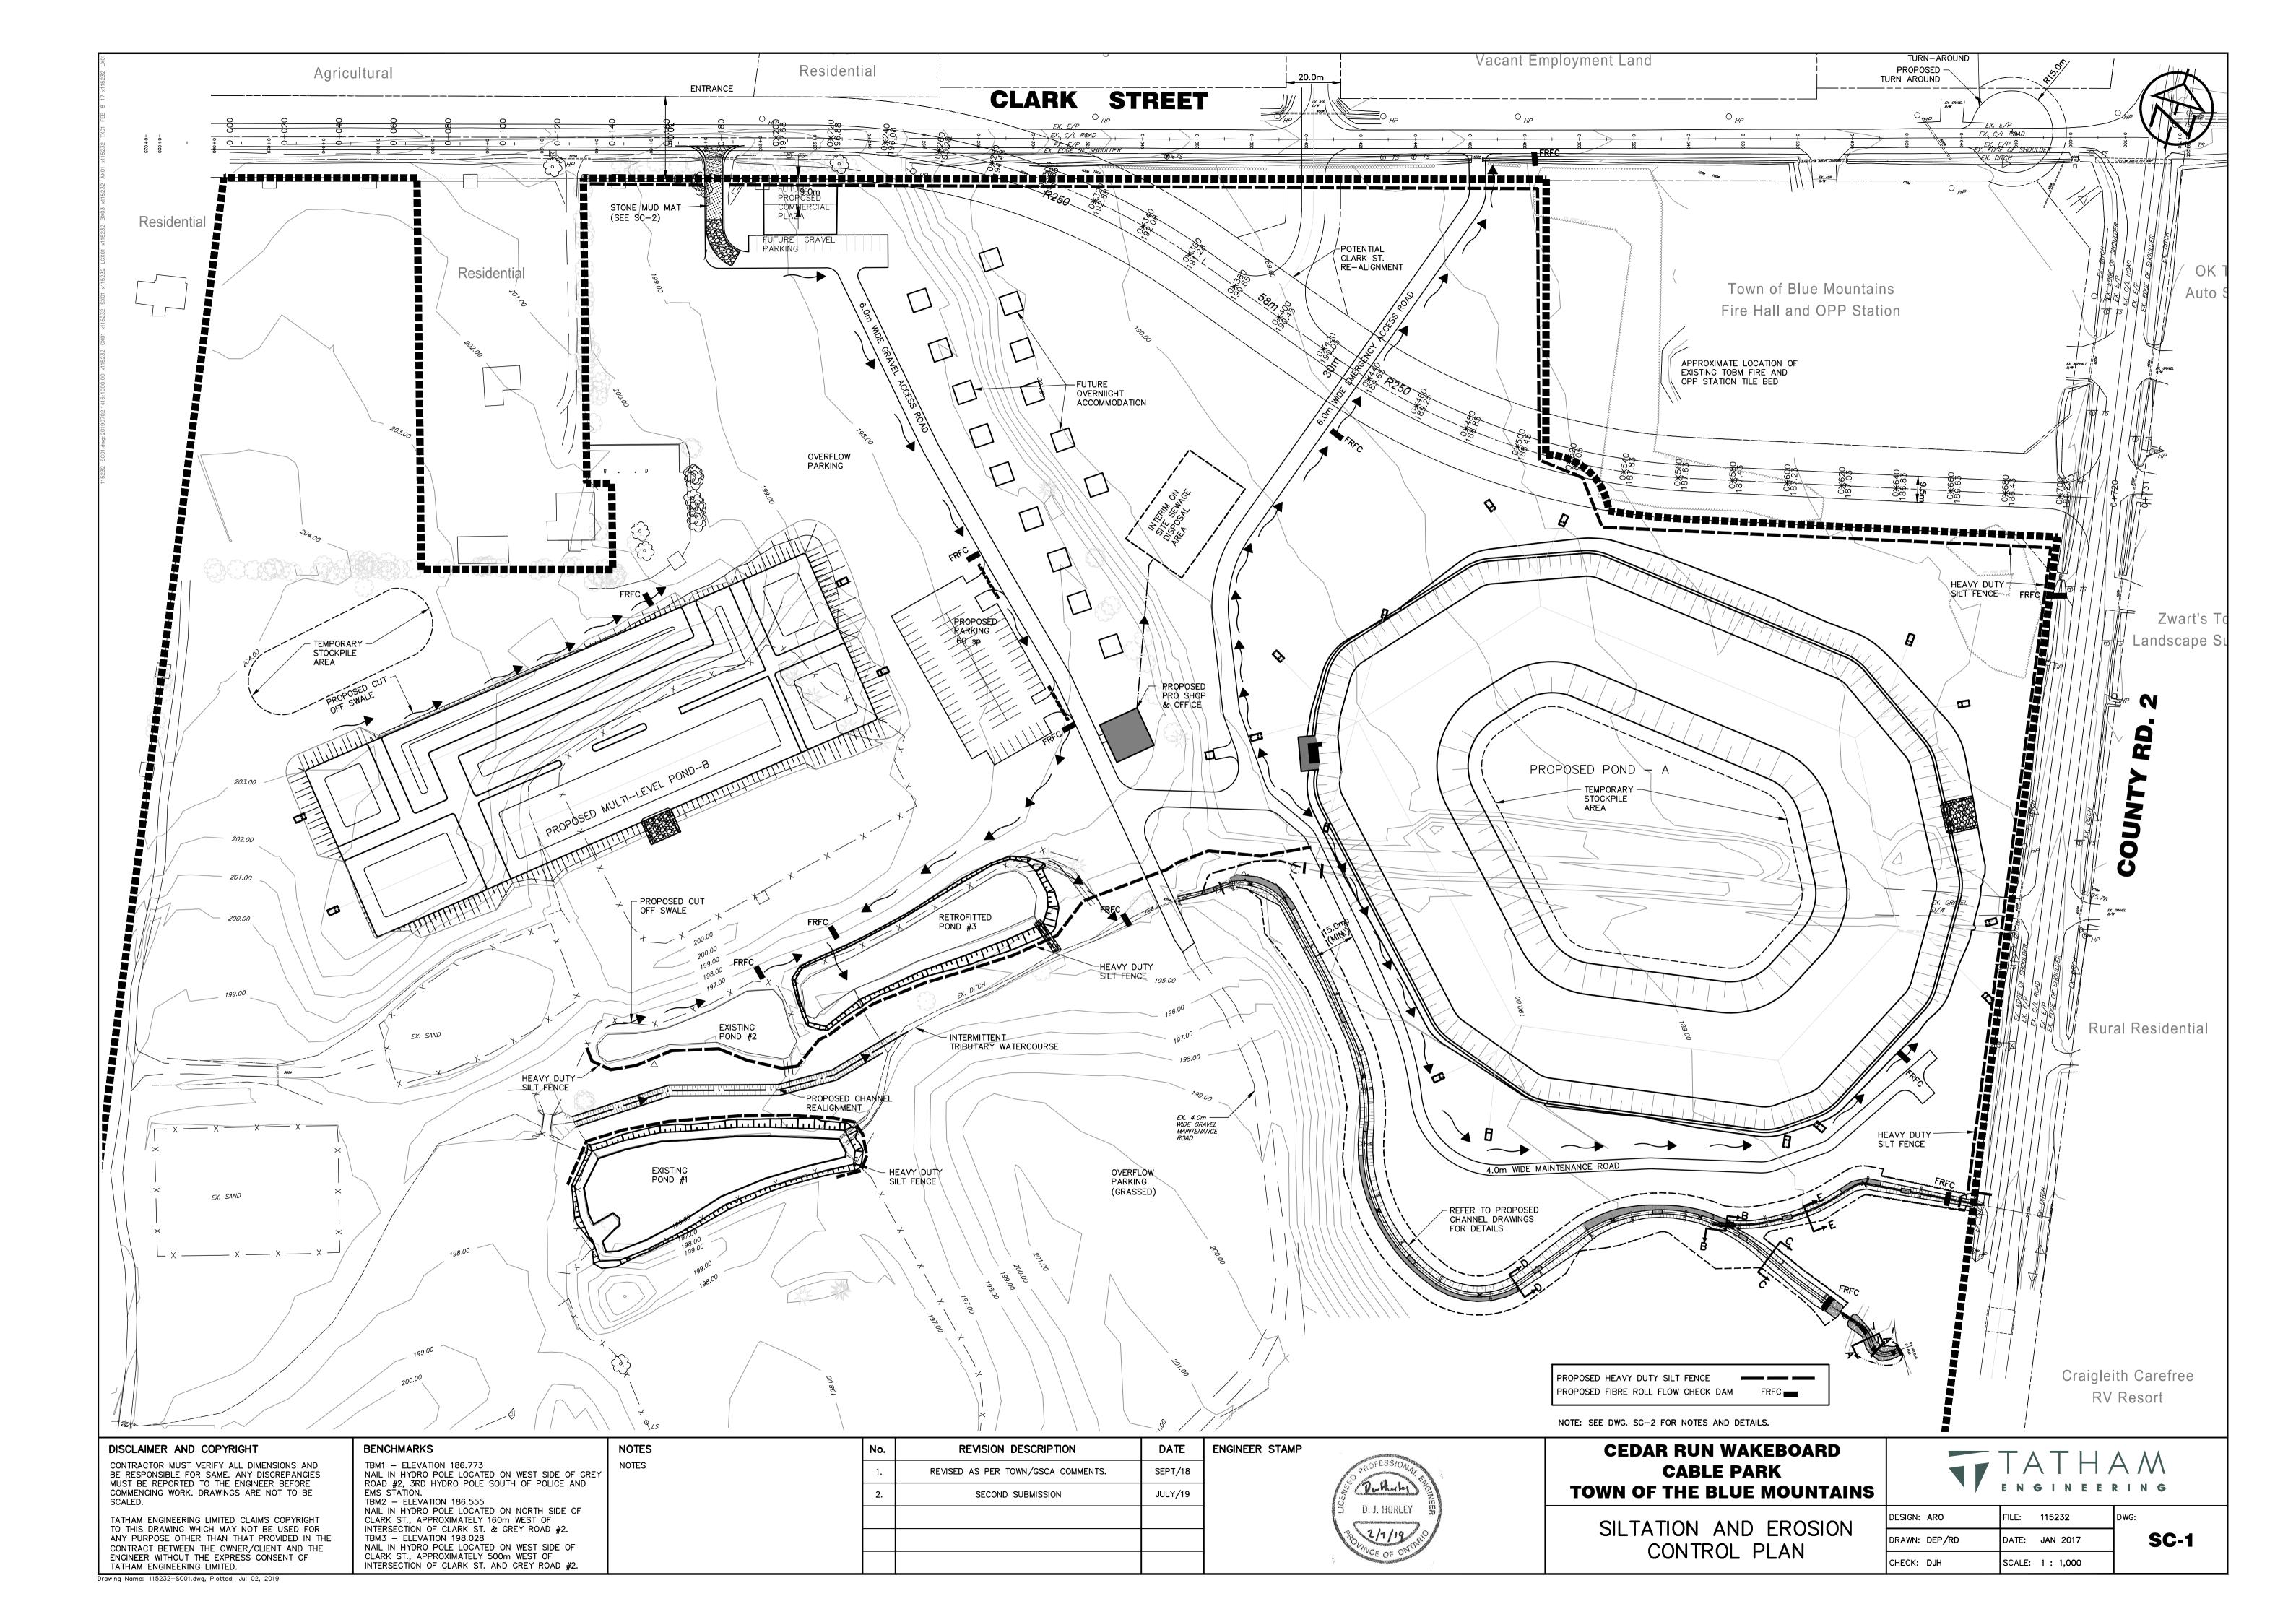


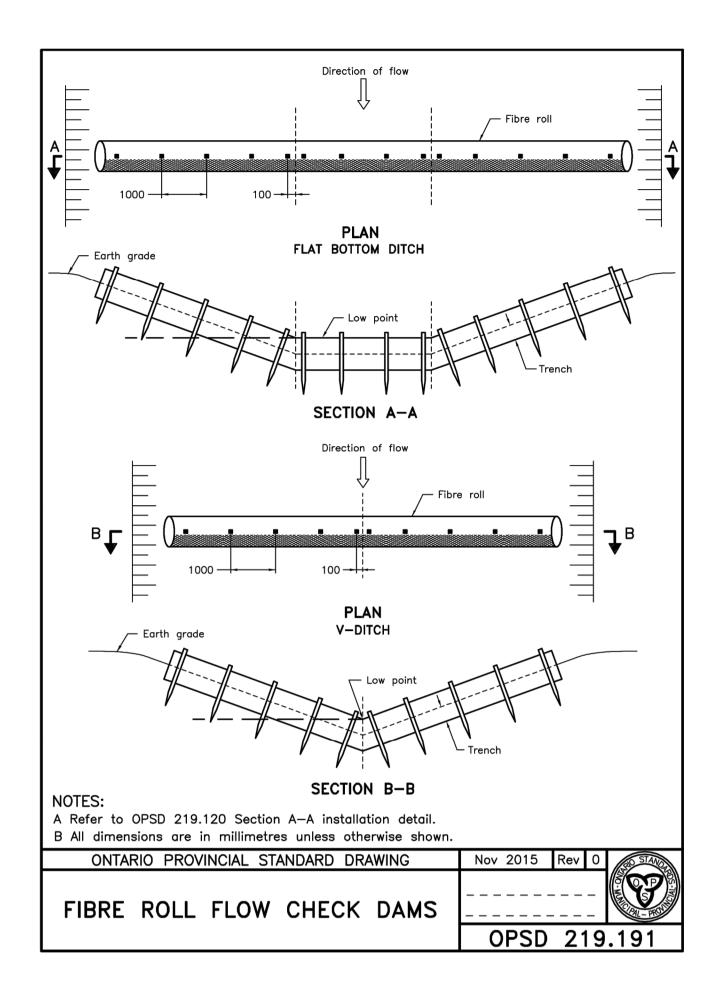

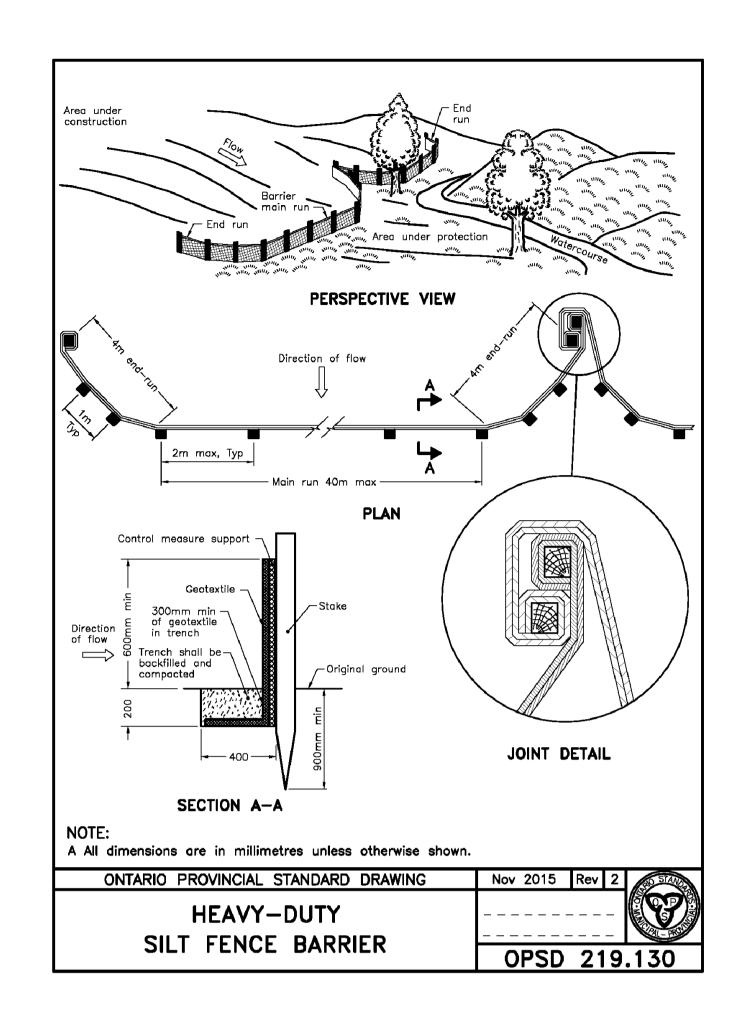

NOTES:

- A. ALL SEDIMENT AND EROSION CONTROL MEASURES SHALL BE INSTALLED PRIOR TO THE COMMENCEMENT OF CONSTRUCTION AND SHALL REMAIN IN PLACE UNTIL ALL DISTURBED AREAS HAVE BEEN STABILIZED. SEDIMENT AND EROSION CONTROL MEASURES THAT ARE DESIGNED TO CONTROL RUNOFF FROM SPECIFIC AREAS MUST BE INSTALLED PRIOR TO ANY DISTURBANCE OF THAT PART OF THE SITE. THE LOCATION OF ALL SILTATION AND EROSION CONTROL WORKS TO BE REVIEWED ON SITE BY THE ENGINEER. THE LOCATION OF SILTATION AND EROSION CONTROL WORKS MAY BE REVISED AS DIRECTED BY THE ENGINEER.
- B. THE CONTRACTOR MAY CONSIDER ALTERNATIVE SEDIMENT AND EROSION CONTROL MEASURES. SUCH MEASURES MUST BE PRESENTED IN WRITING TO THE ENGINEER FOR APPROVAL OF THE TOWN AND GREY SAUBLE CONSERVATION AUTHORITY (GSCA).
- C. THE CONTRACTOR SHALL HAVE MATERIALS AVAILABLE ON—SITE TO REPAIR SEDIMENT AND EROSION CONTROL DEVICES IN THE EVENT OF UNFORESEEN CONDITIONS: HIGH WATER, EXTREME RAINFALL EVENTS, ETC.
- D. ALL EROSION AND SEDIMENT CONTROL DEVICES MUST BE INSPECTED, CLEANED AND MAINTAINED BY THE CONTRACTOR AFTER EACH STORM EVENT. ALL WORKS WILL BE INSPECTED BY THE ENGINEER BI-WEEKLY AND AFTER EACH MAJOR STORM EVENT.
- E. CONSTRUCTION OF ALL SILTATION AND EROSION CONTROL WORKS ARE TO BE IN ACCORDANCE WITH THE FOLLOWING STEPS:
- 1. INSTALL SILT FENCE AS PER OPSD 219.130 AS PER TOWN STANDARD. 2. INSTALL ROCK FLOW CHECK DAM (RFCD) AS PER OPSD 219.210. 3. INSTALL STRAW BALE FLOW CHECK (SBFC) AS PER OPSD 219.180.
- G. ALL CONSTRUCTION VEHICLES TO ACCESS SITE USING THE DESIGNATED CONSTRUCTION ENTRANCES.
- H. EROSION AND SEDIMENT CONTROL MEASURES TO BE REMOVED BY THE CONTRACTOR ONCE GROUND COVER IS ESTABLISHED AND LANDSCAPING IS COMPLETE AND APPROVED BY THE ENGINEER.
- I. EXCAVATED MATERIALS ARE TO BE TRUCKED OFF SITE.
- J. PROVIDE SNOW FENCE OR APPROVED EQUAL ACROSS ALL CONSTRUCTION ENTRANCES DURING PERIODS OF INACTIVITY.
- K. CONSTRUCTION AREAS THAT EXCEED 30 DAYS OF INACTIVITY SHALL BE STABILIZED BY TOPSOIL & SEEDING.
- THE RETROFITTED STORMWATER MANAGEMENT FACILITY, INCLUDING OUTLET STRUCTURE, SHALL BE USED AS THE TEMPORARY SEDIMENT CONTROL BASIN DURING THE COURSE
- M. THE CONTRACTOR SHALL BE RESPONSIBLE FOR SWEEPING ADJACENT ROADS AS REQUIRED THROUGHOUT CONSTRUCTION OR AS DIRECTED BY THE TOWNSHIP, THE ENGINEER, OR THE GREY SAUBLE CONSERVATION AUTHORITY (GSCA)

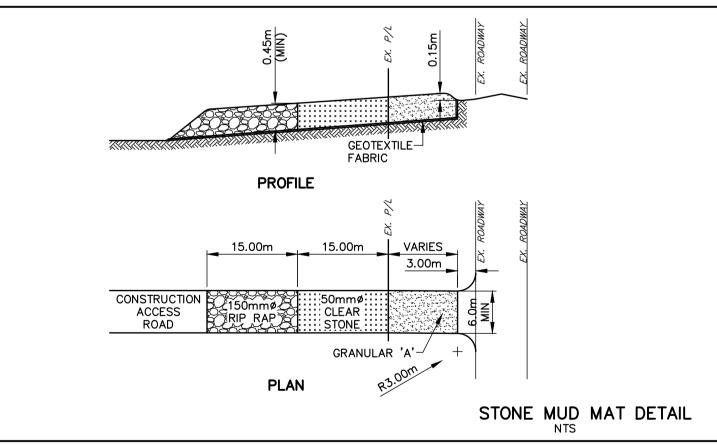

NOTES

ENGINEER STAMP

- 1. STONE SIZE THE STONE PAD SHALL BE A MIN. 450 mm THICK. USE GRANULAR 'A' FOR THE FIRST 5 m FROM THE ENTRANCE/EXIT, 50 mm Ø CLEAR STONE FOR NEXT 15 m AND 150 mm Ø RIP RAP FOR THE REMAINING 15 m.
- 2. LENGTH AS REQUIRED BUT NOT LESS THAN 35 m.
- 3. WIDTH 6.0 m MIN. BUT NOT LESS THAN THE WIDTH AT POINTS WHERE INGRESS AND EGRESS OCCURS.
- 4. GEOTEXTILE FABRIC TERRAFIX 270R OR APPROVED EQUAL TO BE PLACED OVER THE ENTIRE AREA PRIOR TO PLACING STONE.
- 5. SURFACE WATER ALL SURFACE WATER FLOWING OR DIRECTED TOWARD CONSTRUCTION ENTRANCES SHALL BE DIRECTED ACROSS THE ENTRANCE THROUGH A TEMPORARY CULVERT.
- 6. MAINTENANCE THE CONTRACTOR SHALL MAINTAIN THE MUD MAT IN A CONDITION WHICH WILL PREVENT TRACKING OR FLOWING OF SEDIMENT ONTO THE PUBLIC RIGHT—OF—WAY. THIS MAY REQUIRE PERIODIC DRESSING WITH ADDITIONAL STONE AS CONDITIONS DEMAND AND REPAIR AND/OR CLEANOUT OF ANY MEASURES USED TO TRAP SEDIMENT. ALL SEDIMENT SPILLED, DROPPED, WASHED OR TRACKED ONTO THE PUBLIC RIGHT-OF-WAY MUST BE REMOVED IMMEDIATELY BY THE CONTRACTOR.
- 7. WASHING WHEELS SHALL BE CLEANED TO REMOVE SEDIMENT PRIOR TO ENTRANCE ONTO THE PUBLIC RIGHT-OF-WAY. WHEN WASHING IS REQUIRED, IT SHALL BE DONE ON AN AREA STABILIZED WITH STONE AND WHICH DRAINS INTO AN APPROVED SEDIMENT TRAPPING DEVICE.
- 8. INSPECTION & MAINTENANCE REQUIRED MAINTENANCE AFTER EACH RAIN EVENT SHALL BE PROVIDED BY THE
- 9. REMOVAL STONE MUD MAT TO REMAIN IN PLACE UNTIL COMMENCEMENT OF ROAD CONSTRUCTION

DISCLAIMER AND COPYRIGHT				
CONTRACTOR MUST VERIFY ALL DIMENSIONS AND BE RESPONSIBLE FOR SAME. ANY DISCREPANCIES MUST BE REPORTED TO THE ENGINEER BEFORE				

COMMENCING WORK. DRAWINGS ARE NOT TO BE

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BENCHMARKS TBM1 - ELEVATION 186.773 NAIL IN HYDRO POLE LOCATED ON WEST SIDE OF GREY ROAD #2, 3RD HYDRO POLE SOUTH OF POLICE AND EMS STATION. TBM2 - ELEVATION 186.555 NAIL IN HYDRO POLE LOCATED ON NORTH SIDE OF CLARK ST., APPROXIMATELY 160m WEST OF INTERSECTION OF CLARK ST. & GREY ROAD #2. TBM3 - ELEVATION 198.028

NAIL IN HYDRO POLE LOCATED ON WEST SIDE OF

INTERSECTION OF CLARK ST. AND GREY ROAD #2.

CLARK ST., APPROXIMATELY 500m WEST OF

NOTES No. REVISION DESCRIPTION DATE NOTES REVISED AS PER TOWN/GSCA COMMENTS. SEPT/18 SECOND SUBMISSION JULY/19





CEDAR RUN WAKEBOARD CABLE PARK TOWN OF THE BLUE MOUNTAINS


SILTATION AND EROSION CONTROL DETAILS AND NOTES





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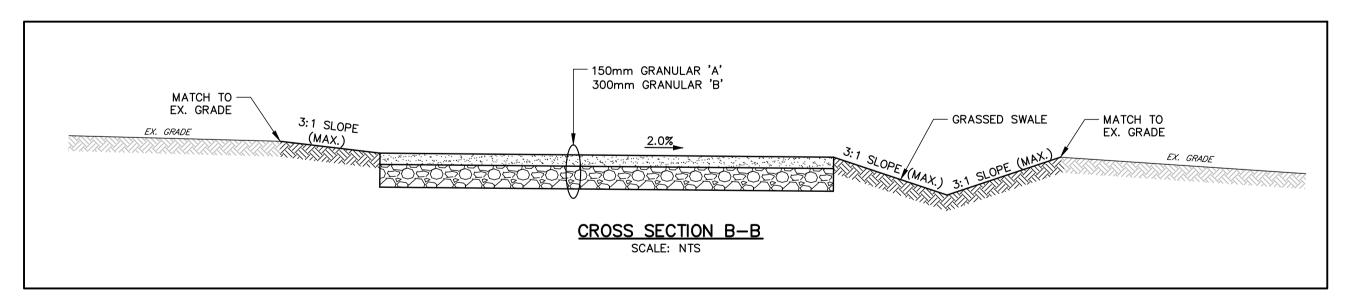


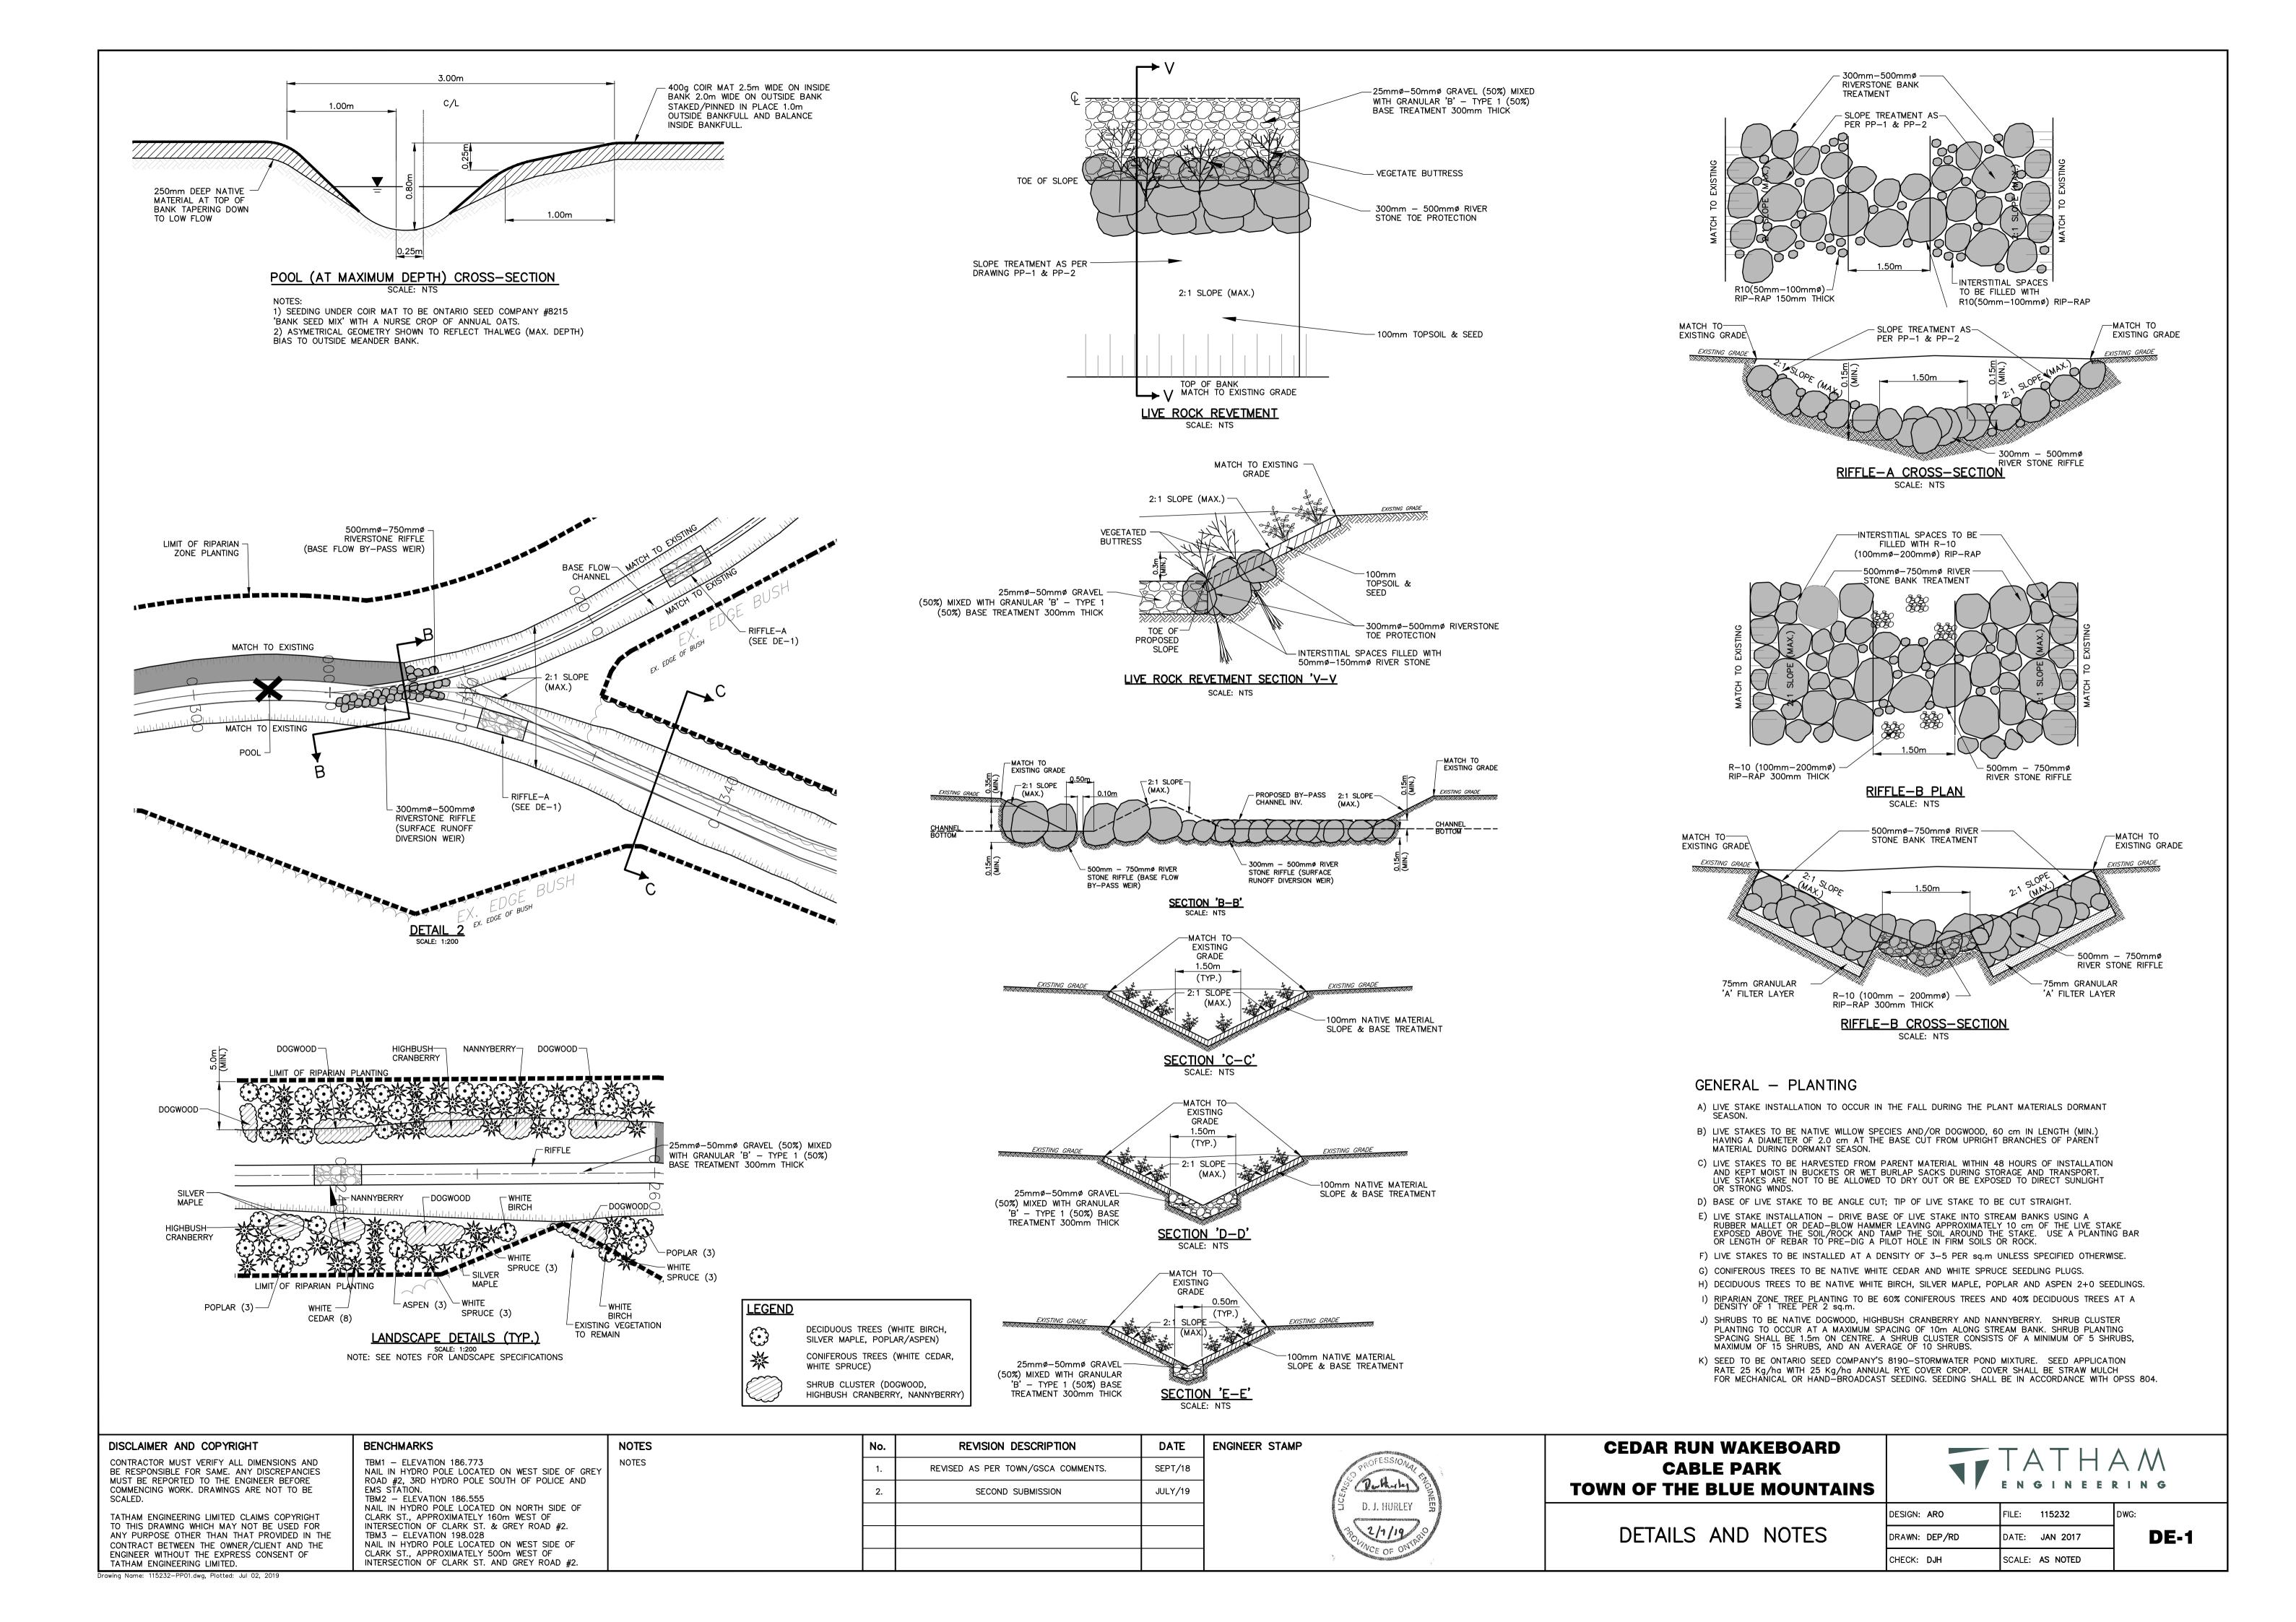

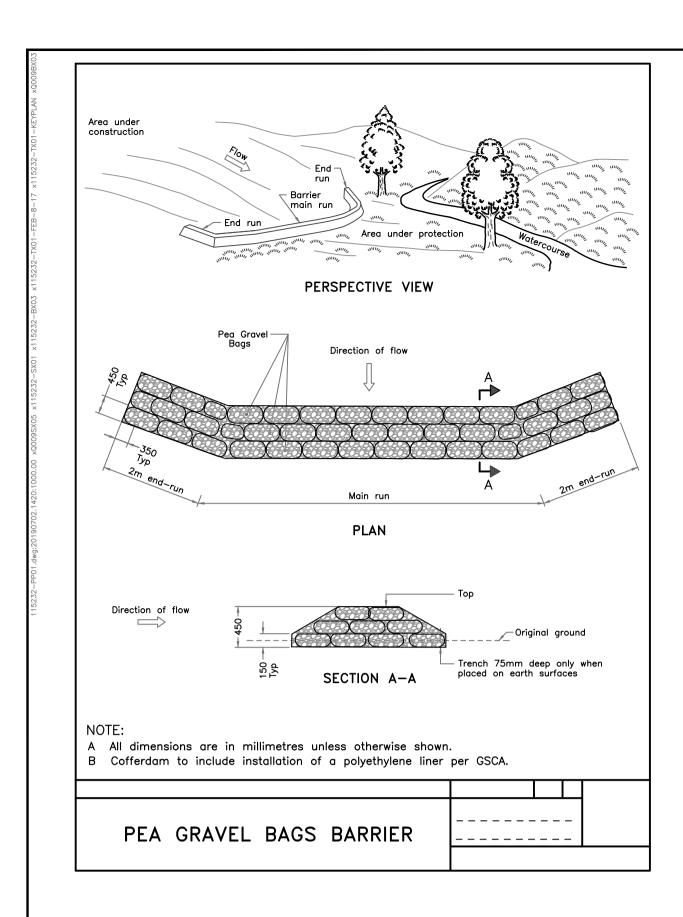

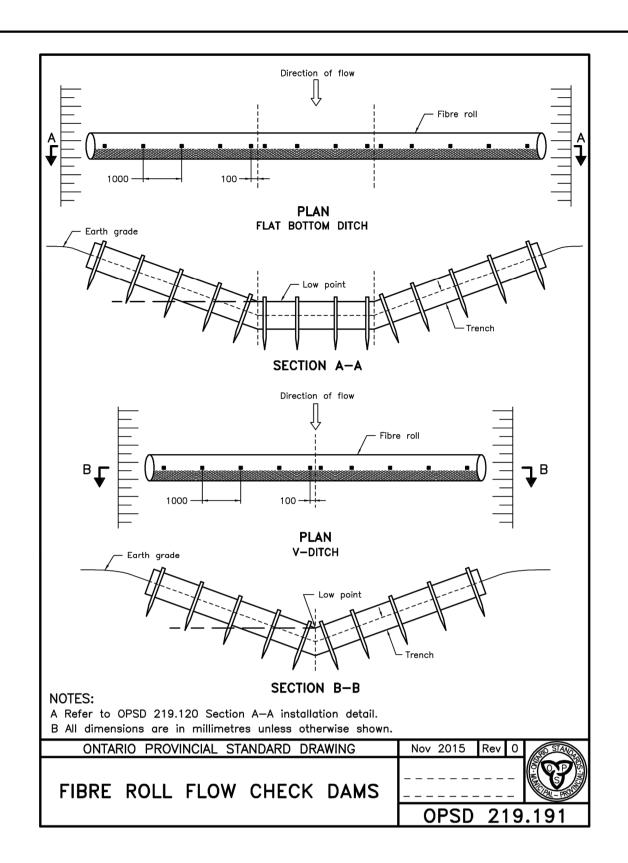

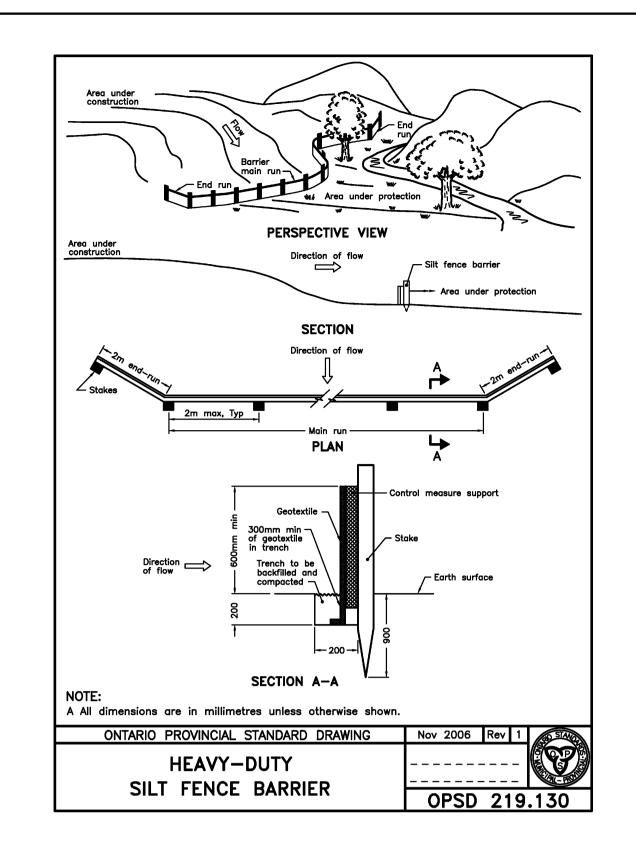

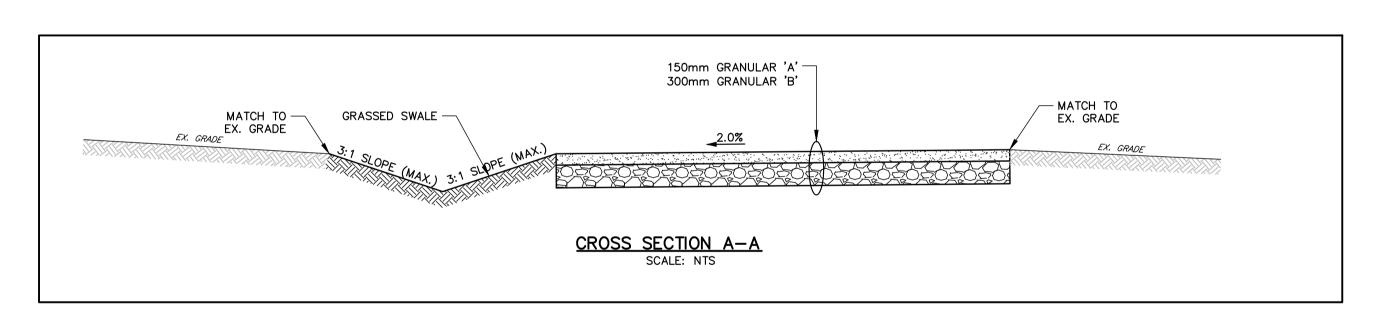

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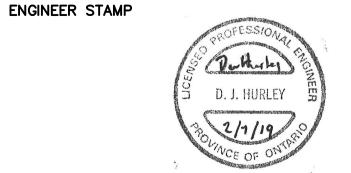
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CEDAR RUN WAKEBOARD CABLE PARK TOWN OF THE BLUE MOUNTAINS

DESIGN: ARO FILE: 115232 DE-2

DETAILS AND NOTES

DRAWN: DEP/RD DATE: **JAN 2017** CHECK: DJH SCALE: AS NOTED